CLIENT:

BORDA BORDA e.V.


PROJECT NAME:


20 m3/Day FSTP at TUNDUMA, TANZANIA

LOCATION:

TUNDUMA, TANZANIA

VICINITY MAP:

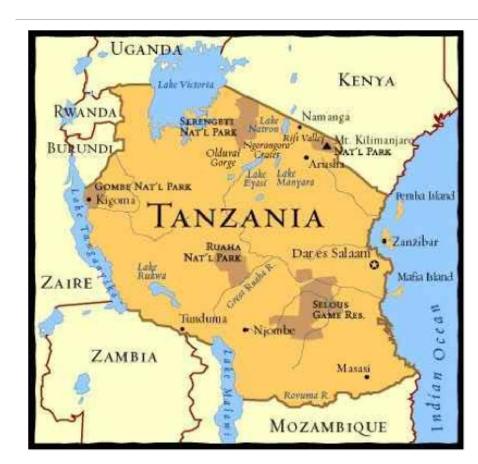

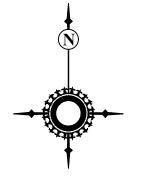

Structural Drawings

A: CODES AND STANDARDS

AS REFERENCED IN THE STRUCTURAL DESIGN FOR BUILDINGS, THE FOLLOWING BRITISH STANDARDS SHALL GOVERN THE CONSTRUCTION, QUALITY CONTROL, AND SAFETY OF ALL STRUCTURAL WORK PERFORMED IN THIS PROJECT: -

- 1. CP3: CHAPTER V: 1972 AND BS6399:2-1997 FOR DESIGN OF WIND LOADS IN BUILDINGS.
- 2. BS8110:2-1997 CODE OF PRACTICE FOR STRUCTURAL USE OF REINFORCED CONCRETE IN BUILDINGS.
- 3. BS5268:1-1985 CODE OF PRACTICE FOR STRUCTURAL USE OF TIMBER.
- 4. BS8002:1-1994 CODE OF PRACTICE FOR EARTH RETAINING STRUCTURES.
- 5. BS5950-1:2000 STRUCTURAL USE OF STEEL WORKS IN BUILDINGS.

B: DIMENSIONS

1. UNLESS OTHERWISE STATED, ALL DIMENSIONS ON THE DRAWINGS ARE IN MILLIMETERS (mm)

C: FLOOR AND ROOF LOADS

PROVISION OF MINIMUM DESIGN LOADS EXPERIENCED IN STRUCTURE WILL BE AS PER THE FOLLOWING SPECIFICATIONS: -

1. DEAD LOAD:

FIRST FLOOR SLABS

(A) SCREED 762244.. 1.20 KN/m²

(B) CEILING AND SERVICES 762244.. 0.50 KN/m²

(C) FLOOR PARTITION AT ANY POINT 762244.. 2.0 KN/m²

2. IMPOSED LOAD:

IMPOSED LOAD ON THE FLOOR SLABS 762244.. 2.0 KN/m²

NOTE: -

GROUND FLOOR SLAB WILL BE THE SLAB ON GRADE WITH MINIMUM REINFORCEMENT FOR CRACK CONTROL

D: WIND LOADS

WIND LOADS HAVE BEEN DESIGNED AS PER THE CP3:CHAPTER V:1972 AND BS6399:2-1997:

- 1. THE DESIGN BASIC WIND SPEED IS 35 m/s
- 2. BUILDING IMPORTANCE AND TYPE FACTOR 1.0

E: GEOTECHNICAL CRITERIA

- 1. FOUNDATION DESIGN WILL BASE ON THE RESULTS AND RECOMMENDATIONS OF THE GEOTECHNICAL INVESTIGATION REPORT PREPARED.
- 2. CURRENTLY FOUNDATION DESIGN IS BASED ON AN ALLOWABLE SOIL BEARING PRESSURE OF 150 $\rm KN/m^2$ AND AN AVERAGE SOIL STIFFNESS MODULUS (Es) OF 5.0 $\rm MN/m^2$.

F: BACKFILL

- 1. CONTRACTOR SHALL ANTICIPATE AND MAKE PROVISIONS FOR ADEQUATE DRAINAGE DURING AND AFTER BACKFILLING.
- 2. BACKFILL MATERIAL PLACED AGAINST FOUNDATION WALLS SHALL BE FREE DRAINING MATERIAL WITH PARTICLE GRADING RANGING FROM 2.5mm TO 20mm FREE FROM DUST, OIL, PAINTS, MUD, ORGANIC WASTES, SALTS AND SHALL NOT INCLUDE SITE EXCAVATED SOIL MATERIALS.
- 3. ALL FILL MATERIAL SHALL BE PLACED IN MAXIMUM LOOSE LIFTS OF 200 mm AND SHALL BE COMPACTED TO DRY DENSITIES OF AT LEAST 95 PERCENT OF THE STANDARD PROCTOR MAXIMUM DRY DENSITY.

G: CAST-IN-PLACE CONCRETE CONSTRUCTION

- 1. DESIGN, CONSTRUCTION, AND QUALITY CONTROL OF ALL CONCRETE WORK SHALL BE IN ACCORDANCE WITH REFERENCED CODES AND STANDARDS
- 2. ALL CONCRETE SHALL BE NORMAL WEIGHT CONCRETE FROM GRANITE AGGREGATE, FINE SAND AND POZOLANA CEMENT.
- 3. CONCRETE CONSTRUCTION AND PROPERTIES SHALL CONFORM TO THE MINIMUM CRITERIA SPECIFIED IN TABLE 1 BELOW.

	TABLE 1 - CONCRETE PROPERTIE	s	
STRUCTURAL ELEMENTS	C MINIMUM ULTIMATE COMPRESSIVE STRENGTH AT 28 DAYS MPa	MAXIMUM WATER CEMENT RATIO	ENTRAINED AIR RANGE (%)
FOUNDATIONS	STRIP FOUNDATIONS: 20 PAD FOUNDATIONS: 25	0.55	2 - 4 %
WALLS & ELEVATED SLABS	25	0.55	4 - 6 %
COLUMNS AND BEAMS	25	0.55	4 - 6 %

- 4. PRE-CONSTRUCTION QUALITY ASSURANCE SUBMITTALS SHALL BE IN ACCORDANCE WITH THE BRITISH STANDARDS
- FIELD QUALITY ASSURANCE REQUIREMENTS FOR CONCRETE CONSTRUCTION, INCLUDING CONCRETE TEST CYLINDERS, SHALL BE IN ACCORDANCE WITH THE REQUIREMENTS OF BRITISH STANDARDS BUILDING CODE REQUIREMENTS FOR REINFORCED CONCRETE

GENERAL NOTES

H: REINFORCEMENT

STEEL REINFORCEMENT FOR CONCRETE SHALL BE HIGH STRENGTH DEFORMED BARS CONFORMING TO BS4449, GRADE 460 AND THE ADDITIONAL REQUIREMENTS LISTED BELOW: -

- 1. THE ACTUAL YIELD STRENGTH BASED ON MILD TESTS SHALL NOT EXCEED THE SPECIFIED YIELD STRENGTH BY MORE THAN 125 MPA
- 2. THE RATIO OF THE ACTUAL ULTIMATE TENSILE STRENGTH TO THE ACTUAL TENSILE YIELD STRENGTH SHALL NOT BE LESS THAN 1.25.
- 3. DETAILS OF STEEL REINFORCEMENT SHALL CONFORM TO BUILDING CODE REQUIREMENTS FOR REINFORCED CONCRETE
- 4. EXPOSURE CONCRETE PROTECTION FOR STEEL REINFORCEMENT OF CAST-IN-PLACE CONCRETE SHALL BE PROVIDED AS SPECIFIED IN TABLE 2 BELOW: -

	TABLE 2 - CONCRI	ETE PROTECT	TON	
STRUCTURAL ELEMENT	NOT EXPOSED TO EARTH OR WEATHER IN	EXPOSED TO WEATHER IN		EARTH
	SERVICE (mm)	Ø16mm OR SMALLER	Ø20mm OR LARGER	FORMED
SLABS	25	40	50	75
BEAMS	35	40	50	75
WALLS	40	40	50	75
FOOTINGS	50	75	75	75

- 5. WHEN REINFORCING STEEL IS NOTED AS CONTINUOUS IN WALLS AND SLABS, STAGGERING SHOULD BE NECESSARY.
- REINFORCING BARS SHOULD CONFORM WITH THE FOLOOWING LAP LENGTHS:

TAE	BLE 3: MINIMUM LA	AP LENGTHS				
	AP LENGTHS GGERED	MINIMUM LAP LENGTHS NOT STAGGERED				
BAR DIA (mm)	n) (mm) (mm)					
10	400	500				
12	500	600				
16	650	800				
20	800	1000				
25	1000	1250				
32	1300	1600				

7. LAP LENGTHS FOR UNEQUAL SIZE BARS SHALL BE BASED ON THE SMALLER BAR.

I: STRUCTURAL TIMBER

- 1. STRUCTURAL TIMBER TO BE USED IN THE ROOF SHALL CONFORM TO BS5268: 1-1985.
- 2. ALL STRUCTURAL TIMBER USED FOR THE ROOF SHOULD HAVE TENSILE STRENGTH PARALLEL TO GRAINS OF 4.50 $\rm N/mm^2$
- $3. \ \mathsf{ALL} \ \mathsf{STRUCTURAL} \ \mathsf{TIMBER} \ \mathsf{USED} \ \mathsf{FOR} \ \mathsf{THE} \ \mathsf{ROOF} \ \mathsf{SHOULD} \ \mathsf{HAVE} \ \mathsf{BENDING} \ \mathsf{STRENGTH} \ \mathsf{PARALLEL} \ \mathsf{TO} \ \mathsf{GRAINS} \ \mathsf{OF} \ \mathsf{7.50} \ \mathsf{N/mm}^2$
- $4. \, ALL \, STRUCTURAL \, TIMBER \, USED \, FOR \, THE \, ROOF \, SHOULD \, HAVE \, COMPRESSION \, STRENGTH \, PARALLEL \, TO \, GRAINS \, OF \, 7.90 \, N/mm^2$
- 4. ALL STRUCTURAL TIMBER TO BE USED IN THE ROOF SHOULD HAVE A LIMIT MOISTURE CONTENT OF 18%

J: ANCHORS AND DOWELS

- 1. ALL ANCHOR BOLTS SHOULD HAVE A DIAMETER OF Ø16mm GRADE 8.8 PROVIDED WITH HOLDING DOWN PLATE OR WITH A MINIMUM RADIUS OF 82 mm FOR THE HOLDING OWN HOOK.
- 2 ALL STEEL BASE PLATES SHOULD HAVE A THICKNESS OF NOT LESS THAN 10mm
- 3. WHENEVER NECESSARY, CONCRETE ADHESIVE ANCHORS SHALL BE INSTALLED TO PROVIDE THE FOLLOWING MINIMUM ALLOWABLE CAPACITIES AND EMBEDMENT (WHEN TESTED IN NORMAL WEIGHT CONCRETE HAVING A MINIMUM 28 DAY COMPRESSIVE STRENGTH OF 25 N/mm²):

K: BLOCK WORK

- 1 FOR GENERAL SETTING OUT OF BLOCKWORK AND BLOCKWORK EXPANSION JOINTS, REFER TO ARCHITECTS DRAWINGS
- 2 ALL LOAD-BEARING BLOCK WALLS TO BE OF SOLID WITH A
 COMPRESSIVE STRENGTH OF NOT NOT LESS THAN 7MPa LAID
 ON IN CLASS II MORTAR WITH 28 DAYS COMPRESSIVE STRENGTH
 OF 7MPa
- 3 BRICK FORCE BARS SHOULD BE PROVIDED WITH MINIMUM
 DIMENSION OF 2.8mm AND YIELD STRENGTH = 485MP AND
 LAP LENGTH OF 400mm MINIMUM
- 4 BRICK FORCE BARS SHOULD BE PROVIDED IN EVERY COURSE
 IN THE FOUNDATION BLOCK WORK UP TO THE THE GROUND FLOOR
 BEAMS AND IN EVERY THIRD COURSE IN THE SUPERSTRUCTURE TIED
 UP INTO STRUCTURAL COLUMNS
- 5 ALL BRICK FORCE BARS SHOULD BE GALVANISED WITH MINIMUM COATING OF 750g/m OF ZINC.

L: LIST OF ABBREVIATIONS

ABR - ALTERNATE BARS REVERSED

ABS - ALTERNATE BARS STEGGERED

CJ - CONSTRUCTION JOINTS

€. CENTRE LINE

- B BOTTOM REINFORCING BARS
- T TOP REINFORCING BARS
- N NEAR FACE REINFORCING BARS
- F FAR FACE REINFORCING BARS
- S SIDE REINFORCING BARS
- Ø₀ BOLT DIAMETER
- $\boldsymbol{t_p}$ THICKNESS OF CONNECTED PART/ BASE PLATE
- Py DESIGN STRENGTH OF STEEL



TUNDUMA WATER SUPPLY AND SANITATION AUTHORITY P.O. Box TUNDUMA

BORDA Bremen Overseas Research and Development Association FUNDED BY

P.O.BOX 1519 Dar es salaam Tanzania www.giz.de

COVID 19 measures and sanitation project i Mbeya and Tunduma

SEPARATOR

NOTES:
 This is the product of BORDA and is not to be copied or reproduced without the permission of BORDA.
 All dimensions are in [mm] unless otherwise specified.
 All concrete works to be cured to British standard BS

ABR - Anaerobic Baffled Reactor

VSF - Vertical Sand Filter


Reactor
AF - Anaerobic Filter
BGD - Biogas Digester
PGF - Planted Gravel
Filter


BL - Bottom Level
GL - Ground Level
PBL - Pipe Inner
Bottom Level
RL - Reference Line WL - Water Level


PHASE DETAILED_STRUCTURAL_DESIGN I.Y


SCALE (AT A3):

01 24/03/2022

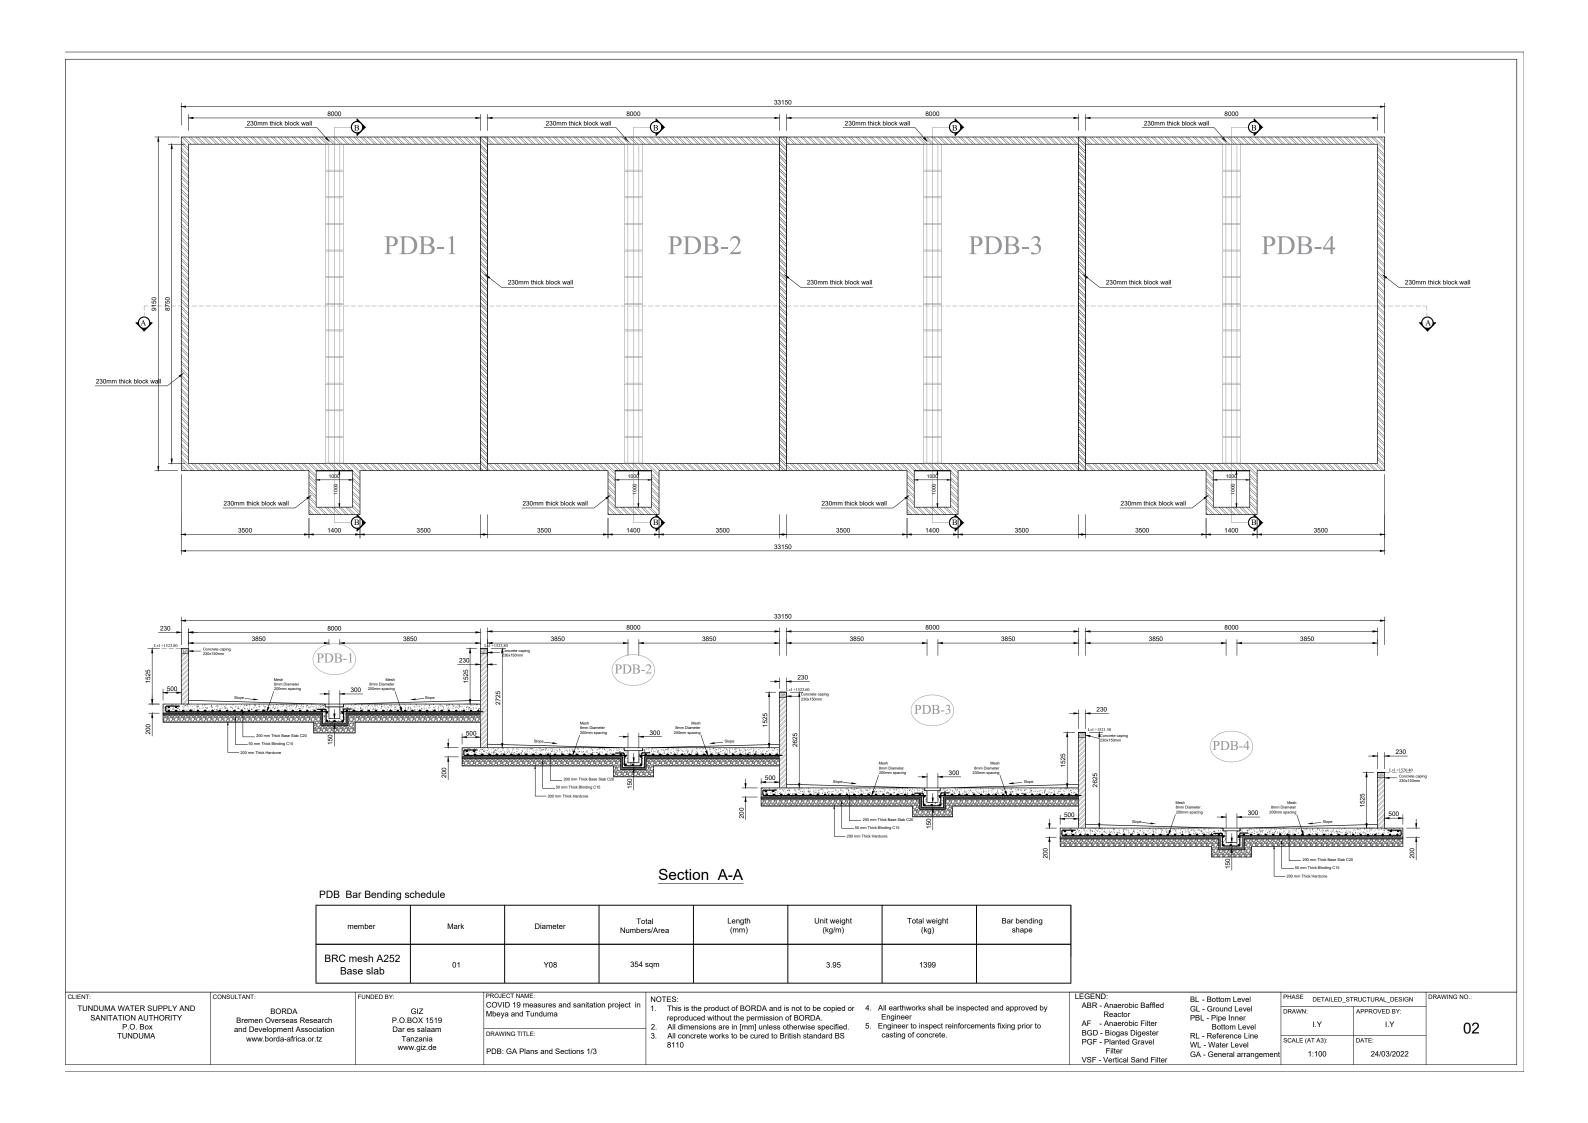

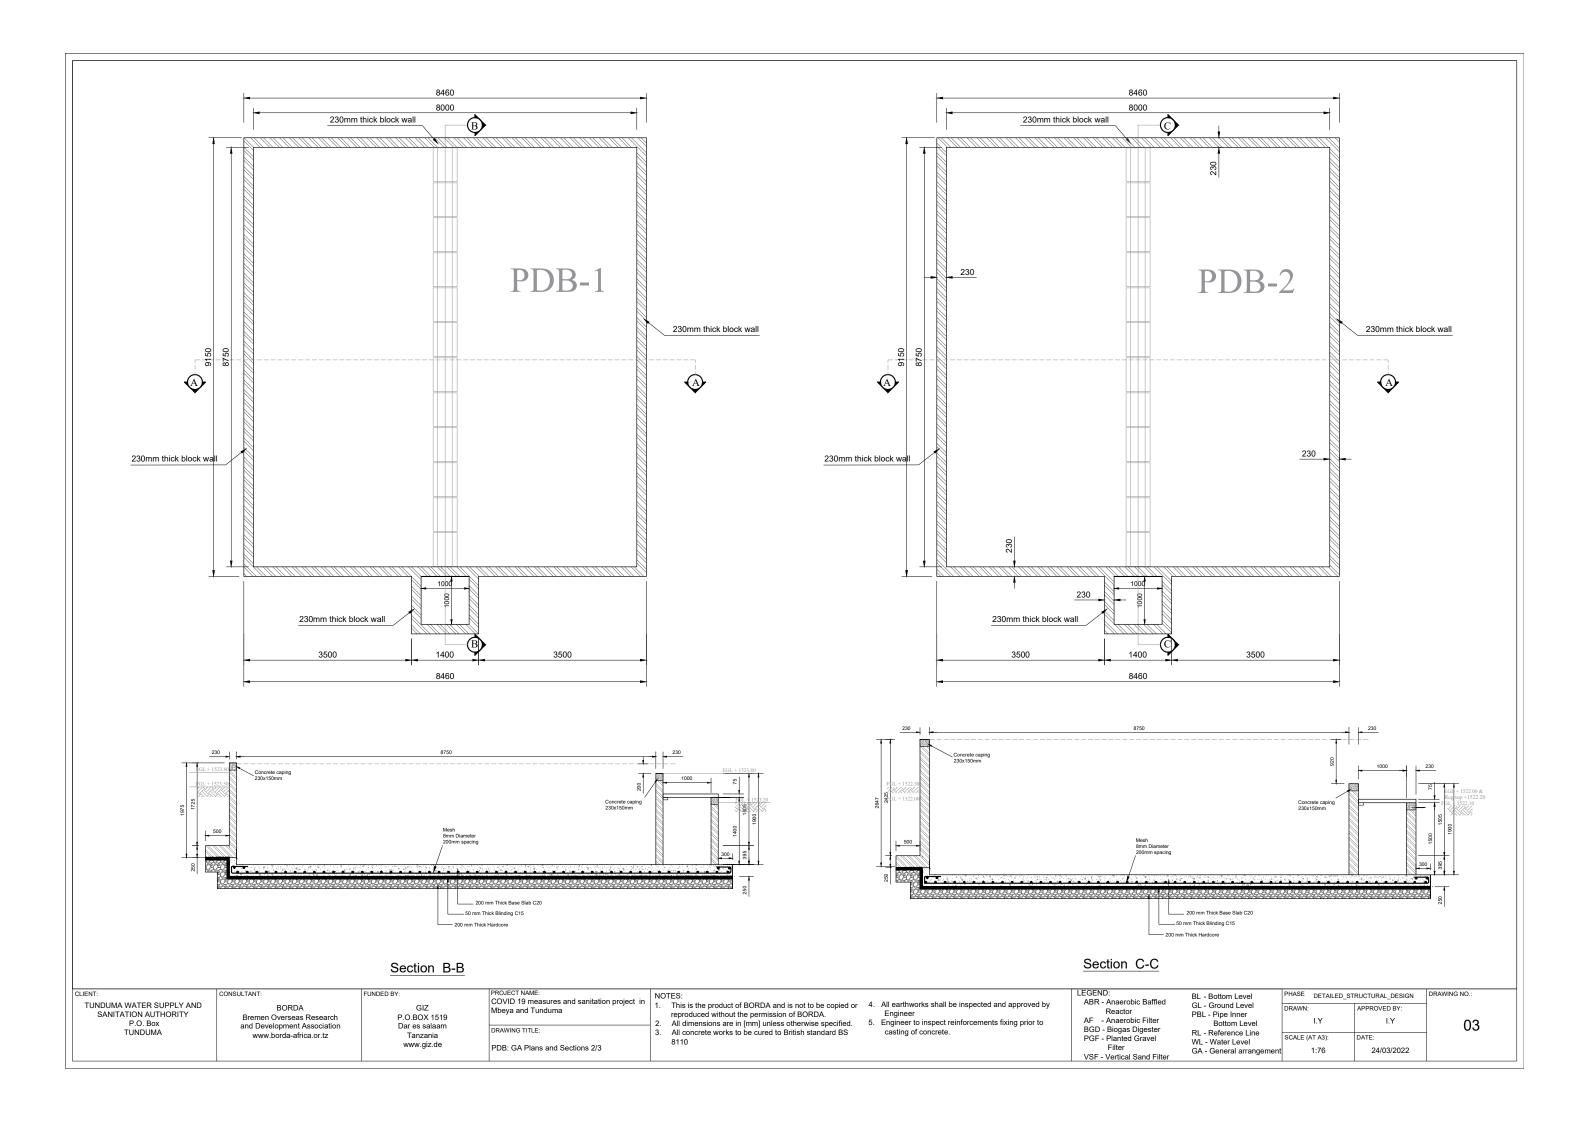

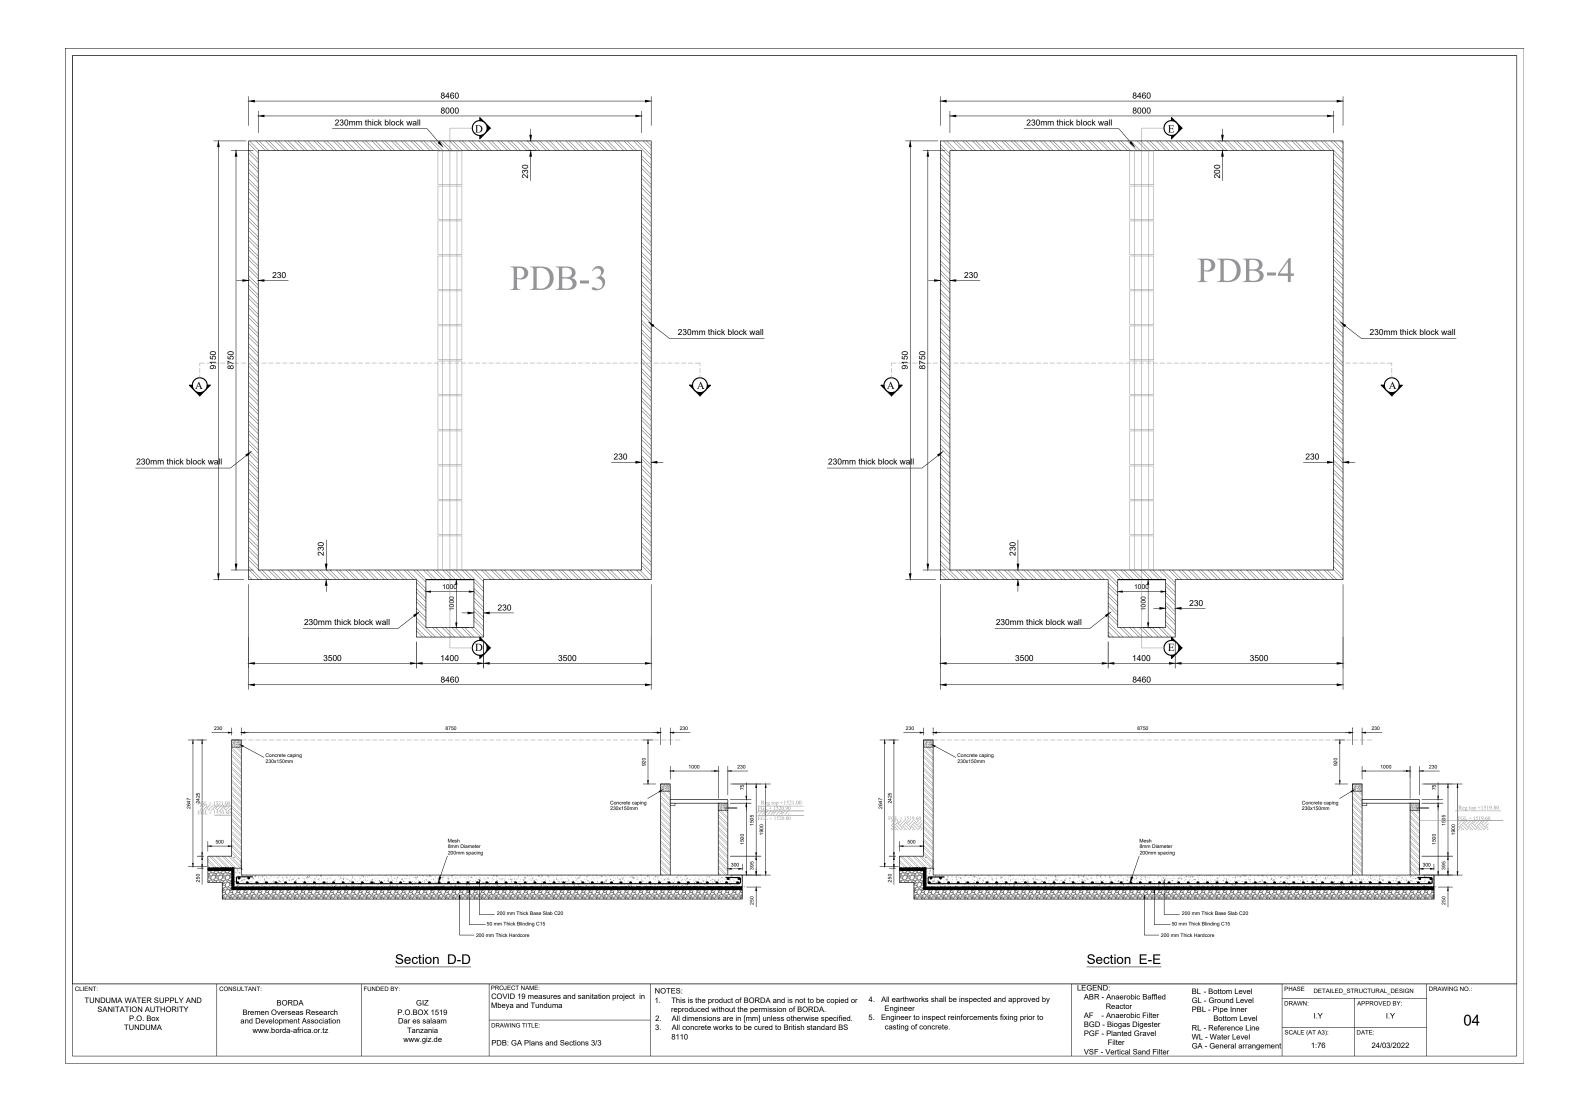

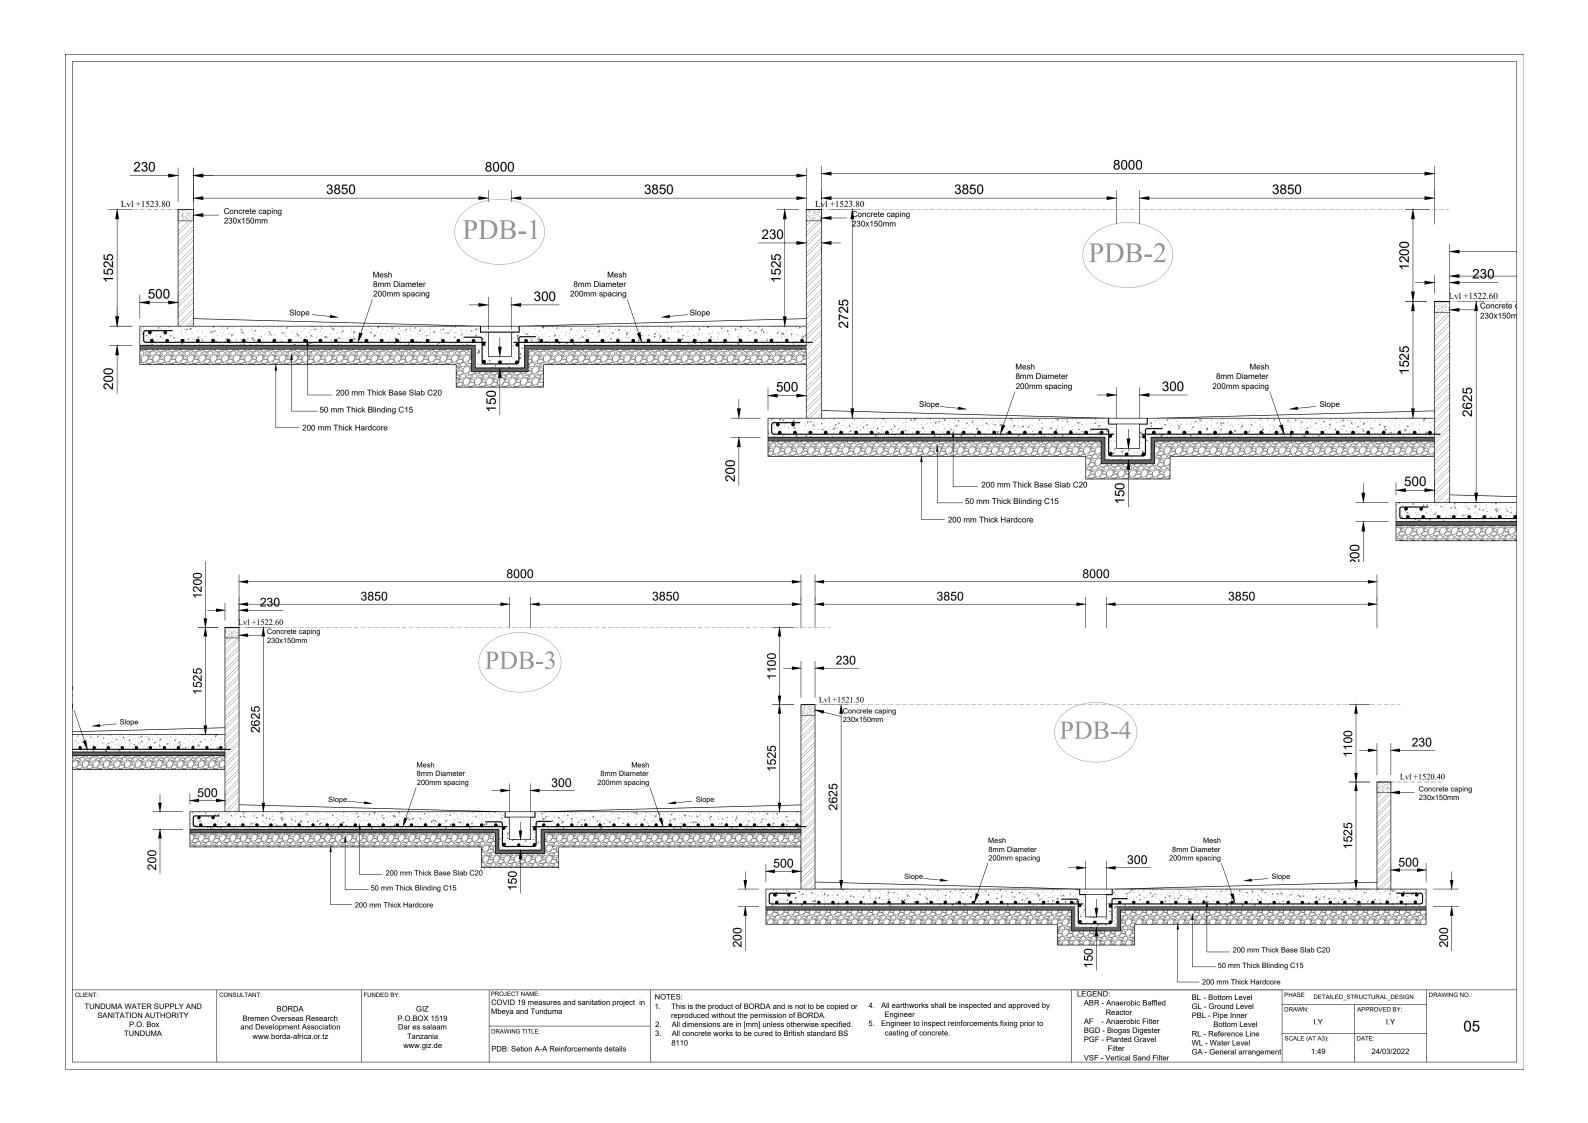



TUNDUMA WATER SUPPLY AND SANITATION AUTHORITY P.O. Box TUNDUMA

BORDA Bremen Overseas Research and Development Association www.borda-africa.or.tz

FUNDED BY: GIZ P.O.BOX 1519 Dar es salaam Tanzania www.giz.de

COVID 19 measures and sanitation project ir Mbeya and Tunduma

SC & ASR SEPARATOR

NOTES:

1. This is the product of BORDA and is not to be copied or reproduced without the permission of BORDA.

2. All dimensions are in [mm] unless otherwise specified.

3. All concrete works to be cured to British standard BS

4. All earthworks shall be inspected and approved by Engineer

5. Engineer to inspect reinforcements fixing prior to casting of concrete.


ABR - Anaerobic Baffled Reactor AF - Anaerobic Filter BGD - Biogas Digester PGF - Planted Gravel Filter


VSF - Vertical Sand Filter


BL - Bottom Level
GL - Ground Level
PBL - Pipe Inner
Bottom Level
RL - Reference Line
WL - Water Level

PHASE DETAILED_STRUCTURAL_DESIGN APPROVED BY:


I.Y 06 SCALE (AT A3): 1:8 24/03/2022

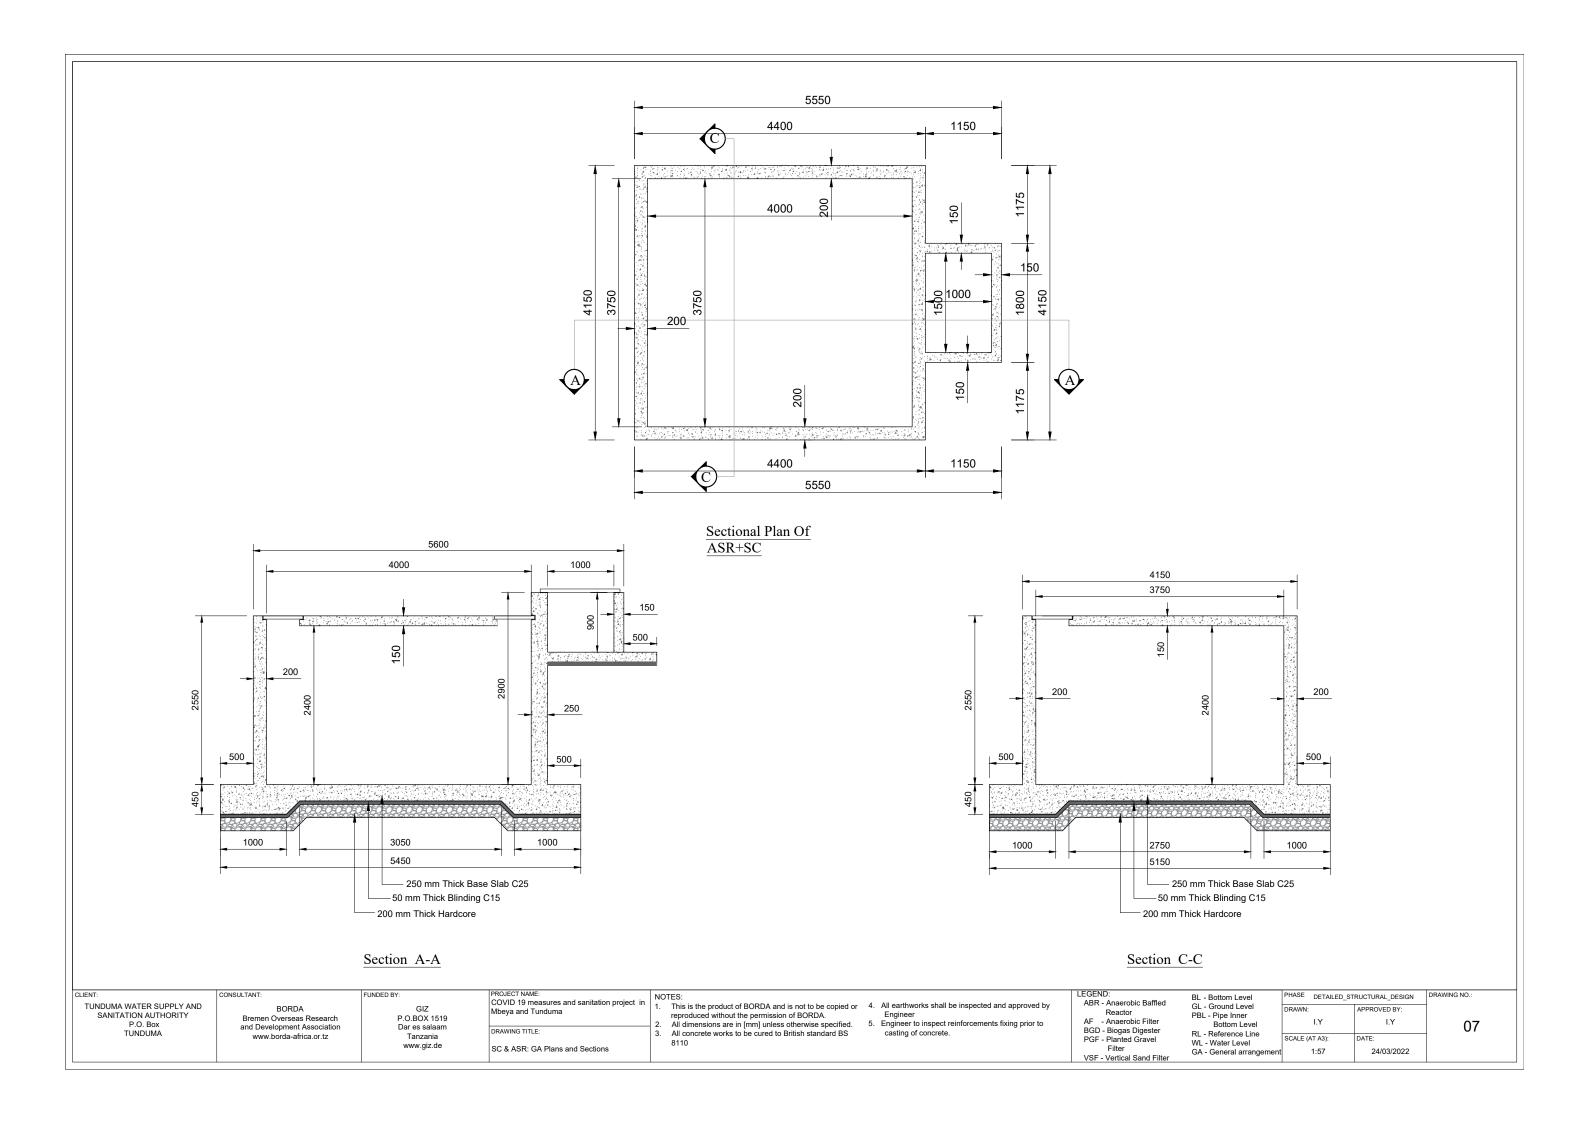

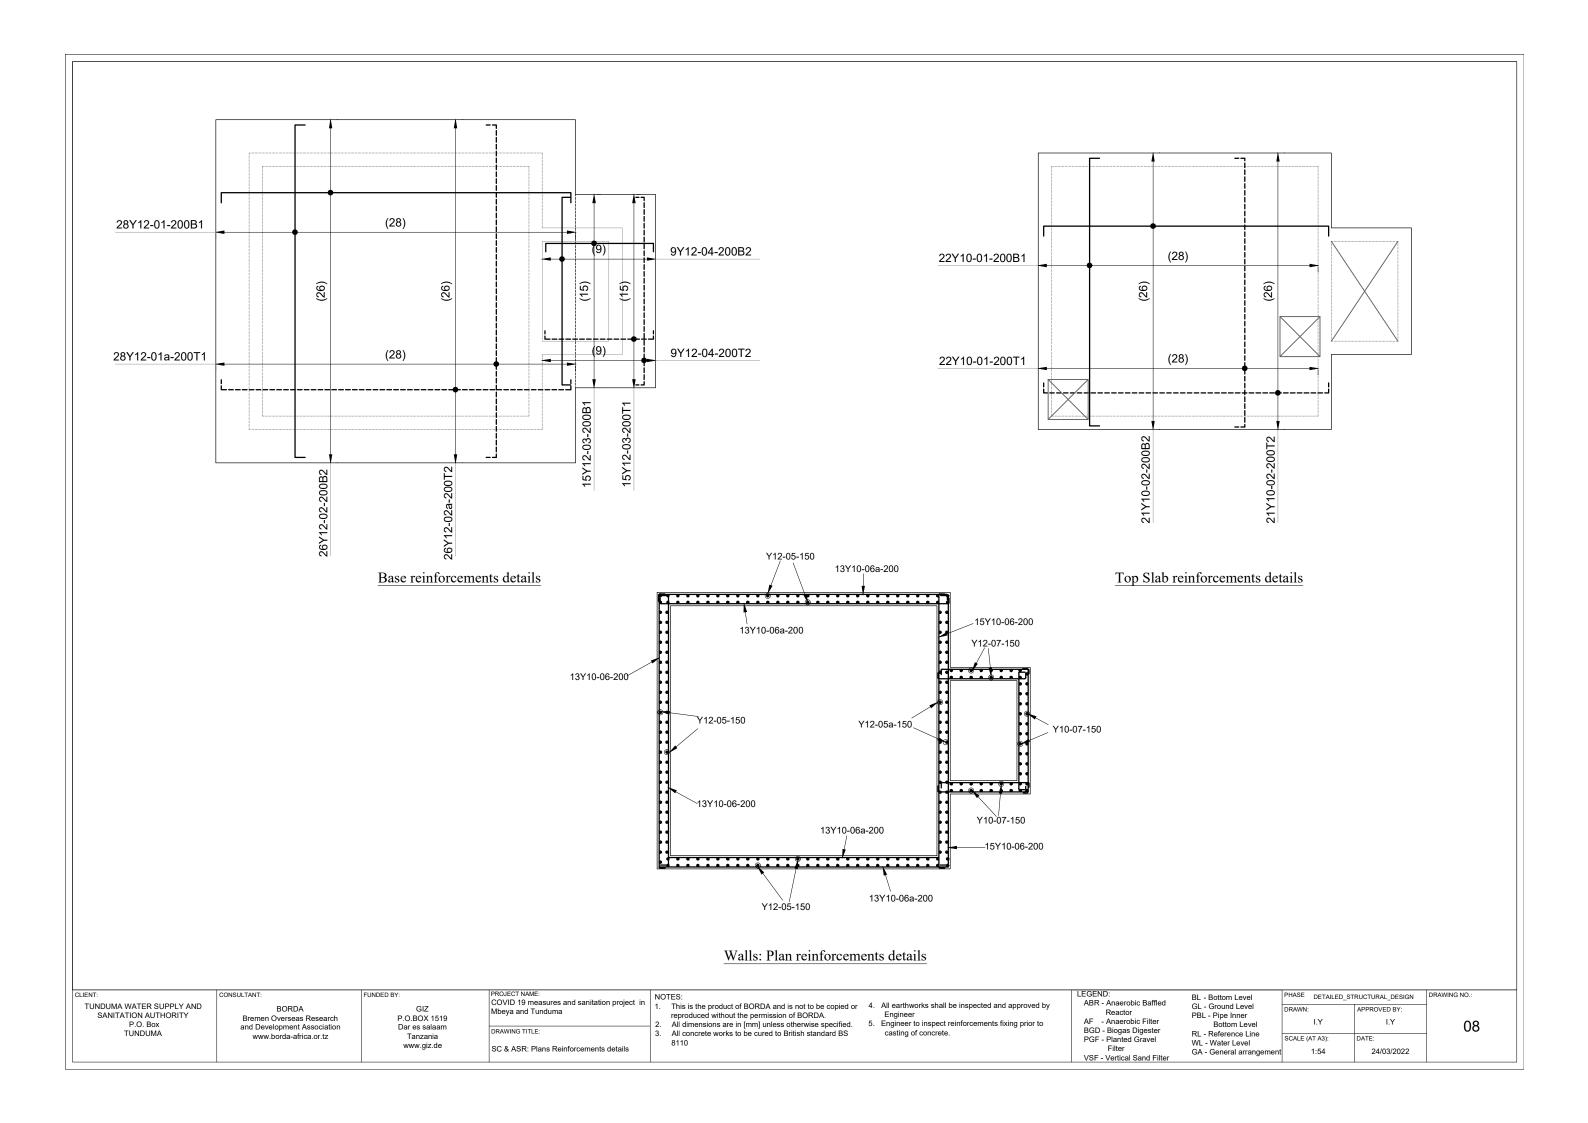

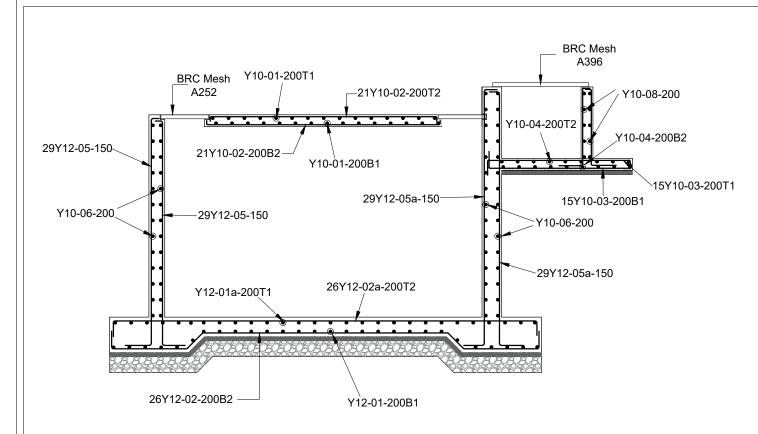

Section A-A reinforcements details

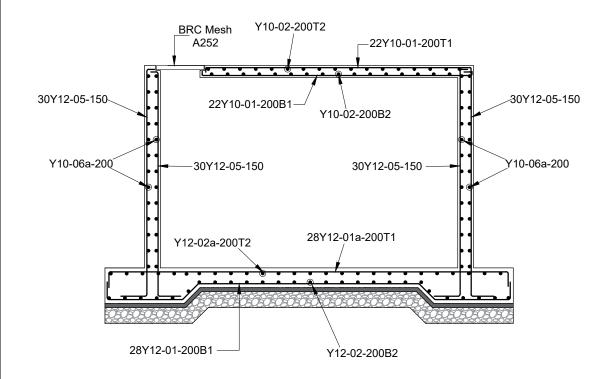

SC + ASR Bar Bending schedule

SC + ASR Bar Bend							
member	Mark	Diameter	Total Numbers/Area	Length (mm)	Unit weight (kg/m)	Total weight (kg)	Bar bending shape
Base	01	Y12	28	5650	0.888	141	
	01a	Y12	28	5400	0.888	135	
	02	Y12	26	6000	0.888	139	
	02a	Y12	26	5700	0.888	132	
	03	Y10	30	2000	0.616	37	
	04	Y10	18	3050	0.616	34	
Walls	05	Y12	210	3250	0.888	606	
	05a	Y12	26	3600	0.888	84	
	06	Y10	56	4270	0.616	148	
	06a	Y10	52	4500	0.616	144	
	07	Y10	52	1300	0.616	42	
	08	Y10	30	1300	0.616	24	
Top slab	01	Y10	44	4300	0.616	117	
	02	Y10	42	4550	0.616	118	
					Total	1,901	

Section C-C reinforcements details

CLIENT:	CONSULTANT:	FUNDED BY:	PROJECT NAME: COVID 19 measures and sanitation project in	NOTES:	LEGEND: ABR - Anaerobic Baffled		PHASE DETAILED_S	TRUCTURAL_DESIGN	DRAWING NO.:
TUNDUMA WATER SUPPLY AND SANITATION AUTHORITY	BORDA Bremen Overseas Research	GIZ P.O.BOX 1519	Mbeya and Tunduma	reproduced without the permission of BORDA. Engineer Engineer	Reactor AF - Anaerobic Filter	PBL - Pipe Inner	DRAWN:	APPROVED BY:	
P.O. Box TUNDUMA	and Development Association www.borda-africa.or.tz	Dar es salaam Tanzania	DRAWING TITLE:	All dimensions are in [mm] unless otherwise specified. All concrete works to be cured to British standard BS 8110	BGD - Biogas Digester PGF - Planted Gravel	Bottom Level RL - Reference Line WL - Water Level	SCALE (AT A3):	DATE:	09
		www.giz.de	SC & ASR: Sections Reinforcements details	0110	Filter VSF - Vertical Sand Filter	GA - General arrangement	1:45	24/03/2022	



TUNDUMA WATER SUPPLY AND SANITATION AUTHORITY P.O. Box TUNDUMA

BORDA Bremen Overseas Research and Development Association www.borda-africa.or.tz

FUNDED BY: GIZ P.O.BOX 1519 Dar es salaam Tanzania www.giz.de COVID 19 measures and sanitation project in Mbeya and Tunduma

ISAF& PGF SEPARATOR

NOTES:

1. This is the product of BORDA and is not to be copied or reproduced without the permission of BORDA.

2. All dimensions are in [mm] unless otherwise specified.

3. All concrete works to be cured to British standard BS

4. All earthworks shall be inspected and approved by Engineer

5. Engineer to inspect reinforcements fixing prior to casting of concrete.


ABR - Anaerobic Baffled Reactor AF - Anaerobic Filter BGD - Biogas Digester PGF - Planted Gravel Filter


VSF - Vertical Sand Filter


BL - Bottom Level GL - Ground Level PBL - Pipe Inner Bottom Level RL - Reference Line WL - Water Level

PHASE DETAILED_STRUCTURAL_DESIGN

I.Y 10 SCALE (AT A3): 1:8 24/03/2022

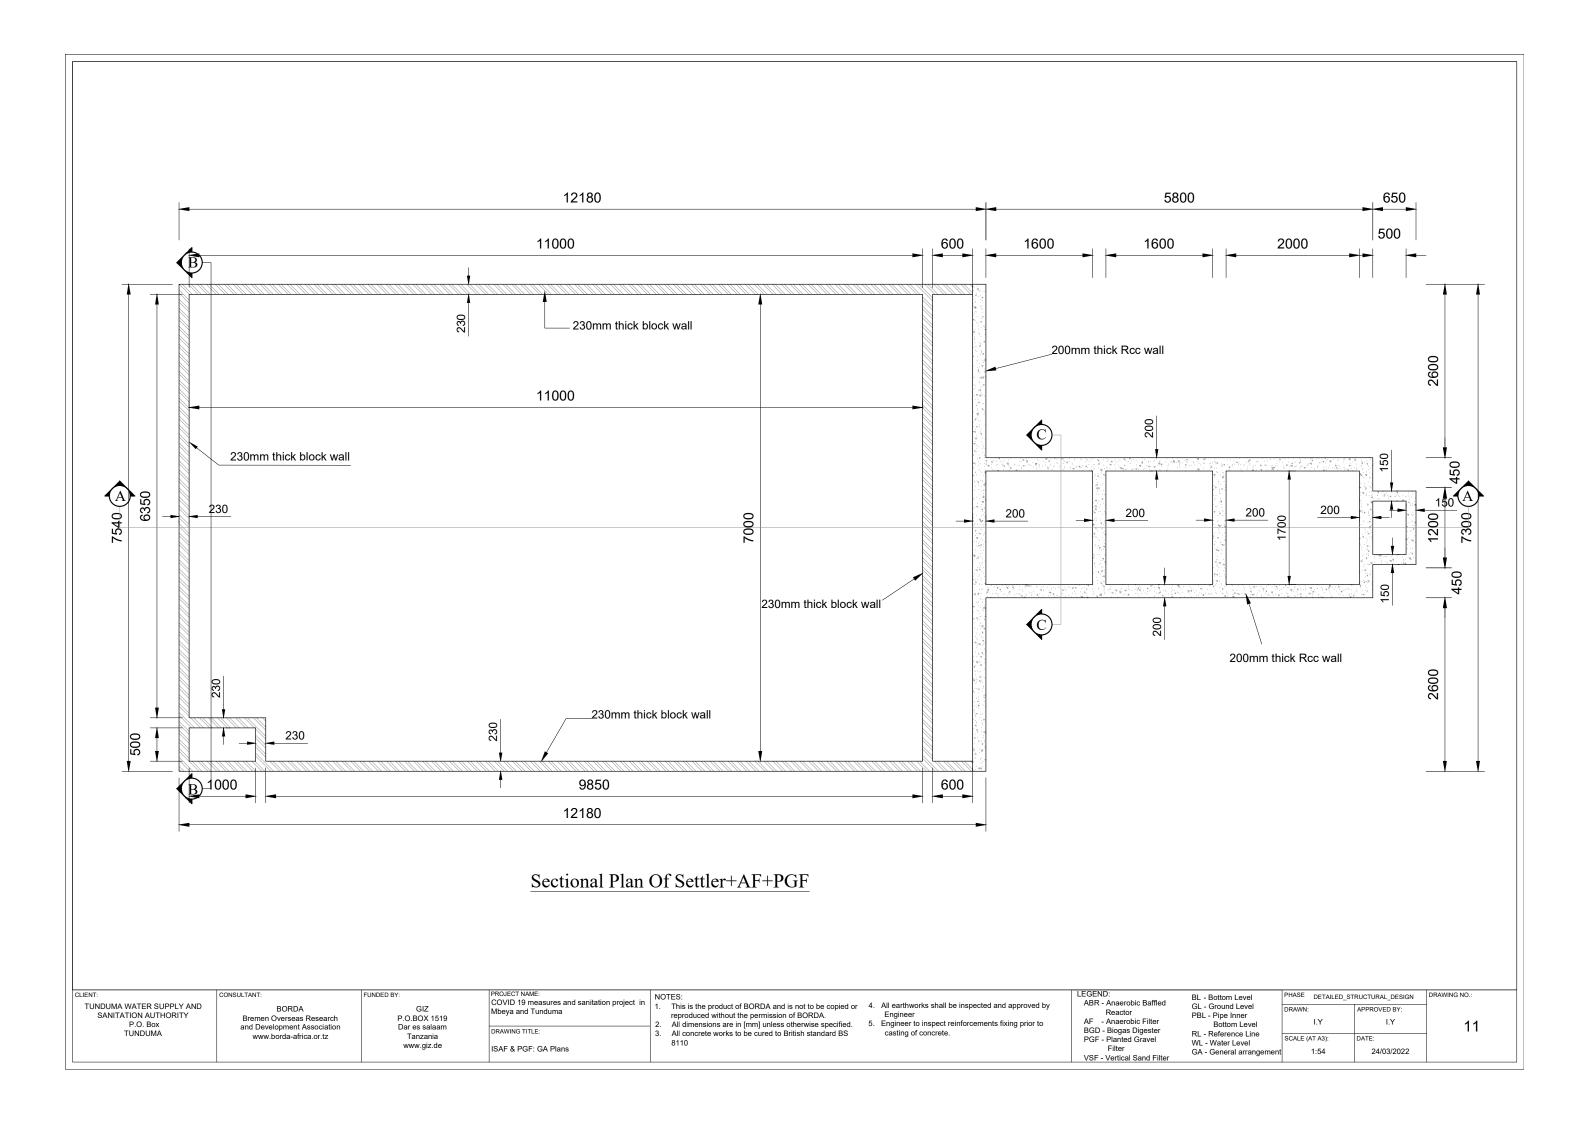


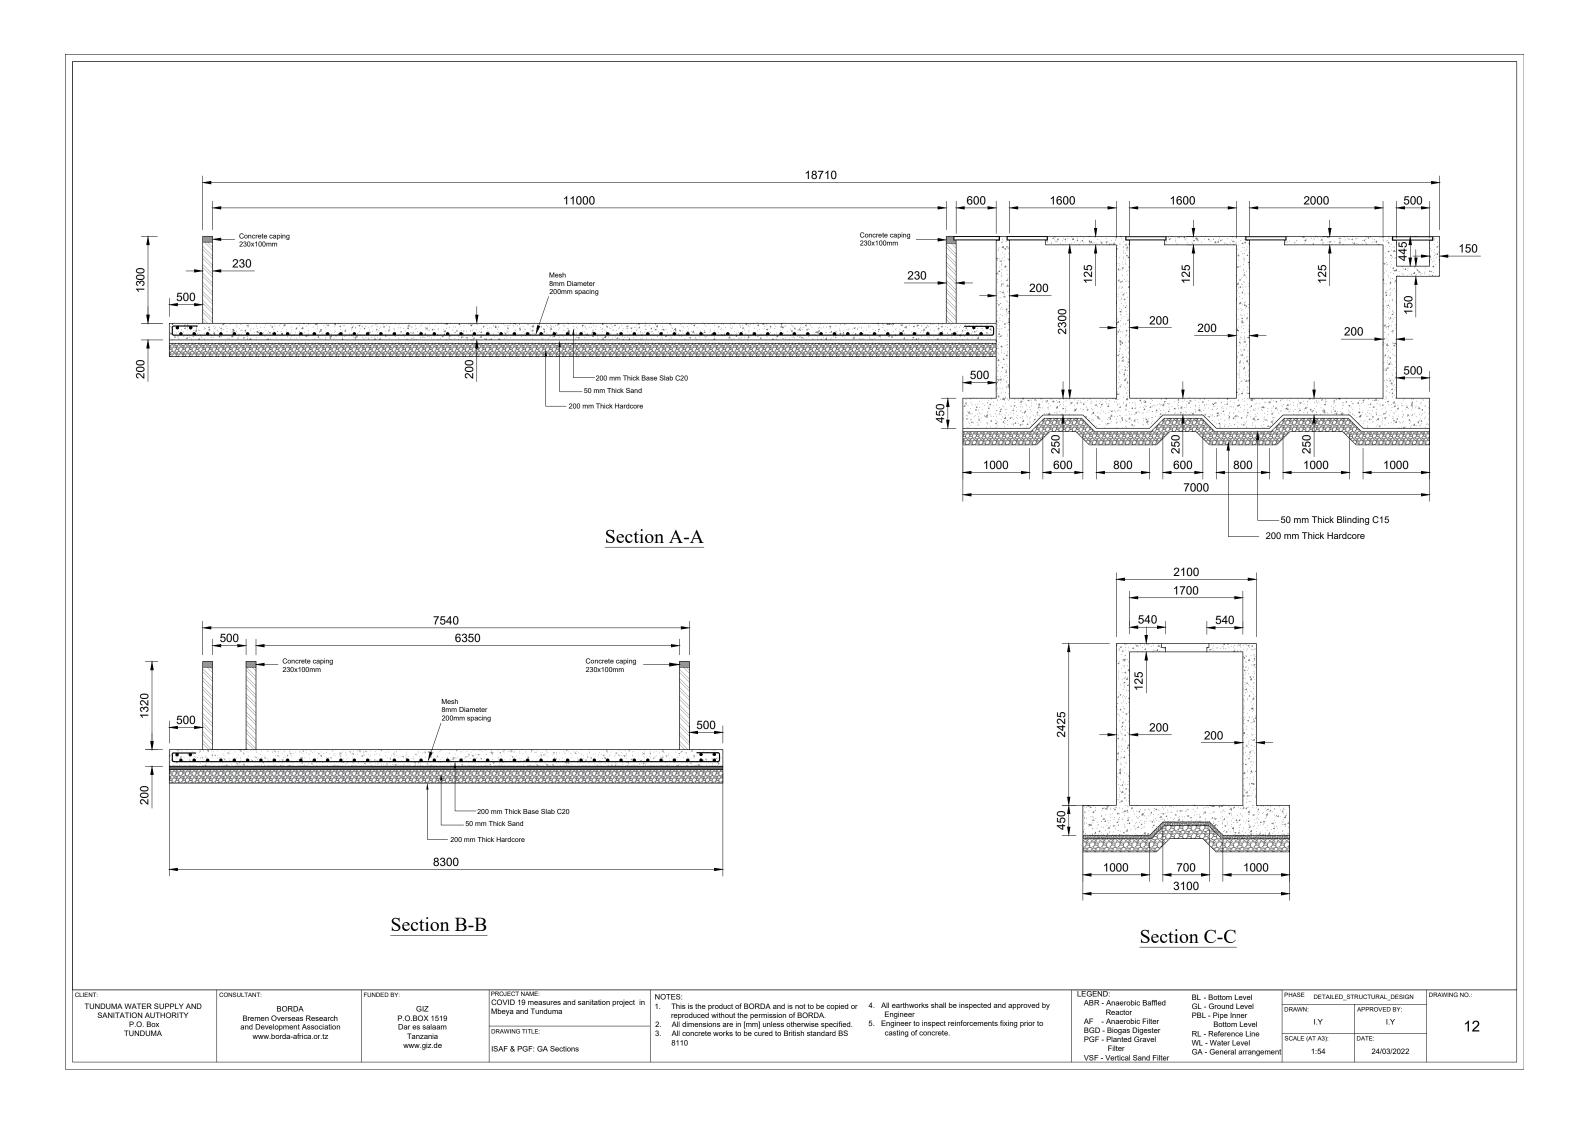

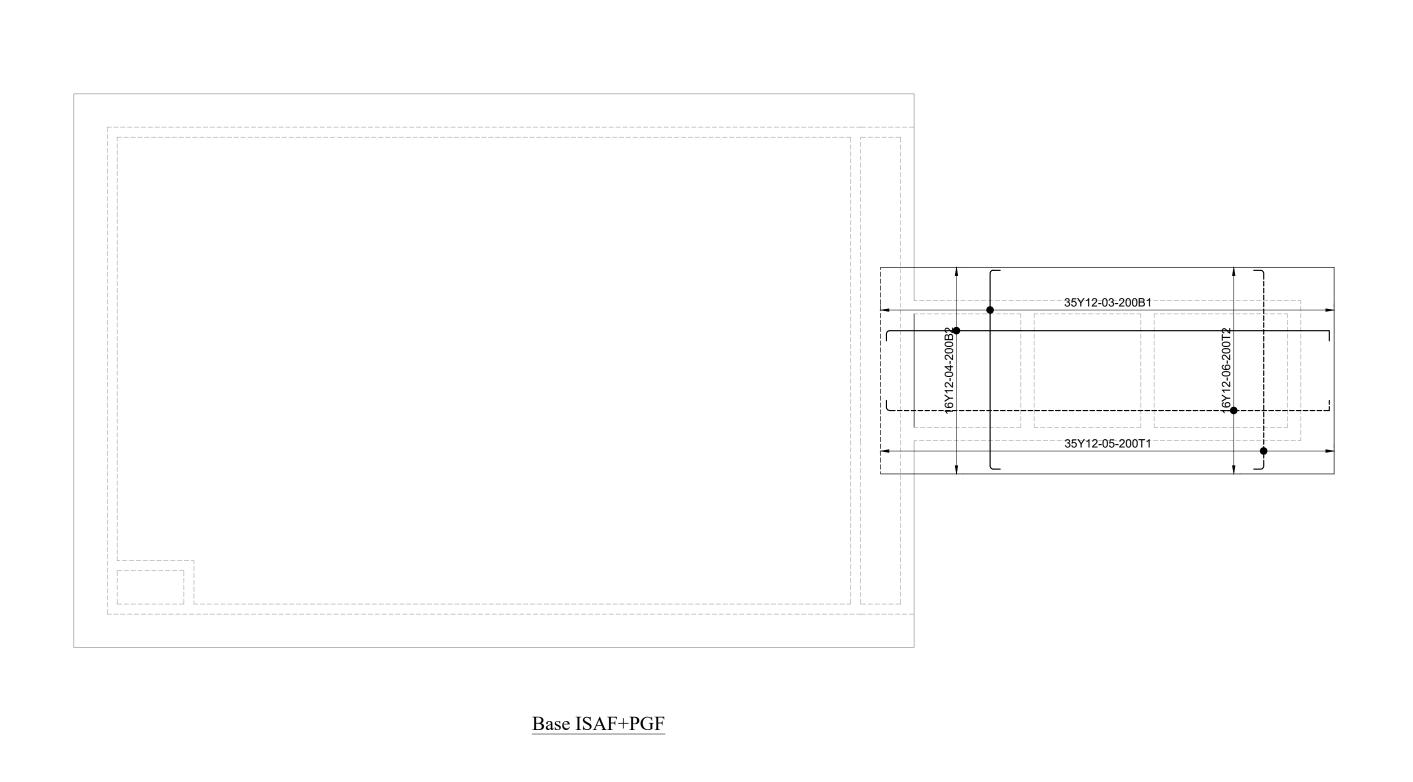

BL - Bottom Level
GL - Ground Level
PBL - Pipe Inner
Bottom Level
RL - Reference Line
WL - Water Level
GA - General arrangement NOTES:
1. This is the product of BORDA and is not to be copied or reproduced without the permission of BORDA.
2. All dimensions are in [mm] unless otherwise specified.
3. All concrete works to be cured to British standard BS


4. All earthworks shall be inspected and approved by Engineer
5. Engineer to inspect reinforcements fixing prior to casting of concrete. LEGEND: FUNDED BY: PHASE DETAILED_STRUCTURAL_DESIGN ABR - Anaerobic Baffled Reactor AF - Anaerobic Filter BGD - Biogas Digester PGF - Planted Gravel Filter TUNDUMA WATER SUPPLY AND SANITATION AUTHORITY P.O. Box TUNDUMA COVID 19 measures and sanitation project in Mbeya and Tunduma BORDA Bremen Overseas Research and Development Association GIZ P.O.BOX 1519 Dar es salaam Tanzania www.giz.de APPROVED BY: I.Y 13 www.borda-africa.or.tz SCALE (AT A3): 8110 ISAF & PGF: Base Reinforcements details 1:54 24/03/2022 VSF - Vertical Sand Filter

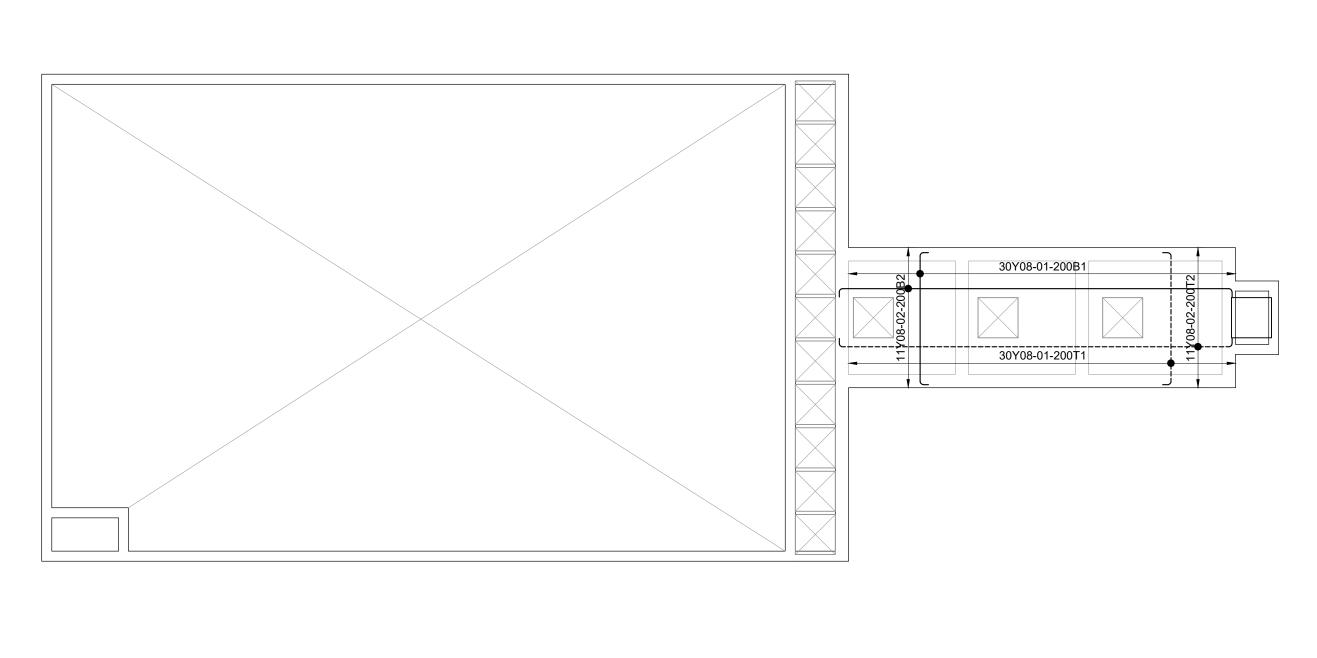


Top Slab ISAF+PGF

LEGEND:
ABR - Anaerobic Baffled
Reactor
AF - Anaerobic Filter
BGD - Biogas Digester
PGF - Planted Gravel
Filter
VSF - Vertical Sand Filter BL - Bottom Level
GL - Ground Level
PBL - Pipe Inner
Bottom Level
RL - Reference Line
WL - Water Level
GA - General arrangement NOTES:
1. This is the product of BORDA and is not to be copied or reproduced without the permission of BORDA.
2. All dimensions are in [mm] unless otherwise specified.
3. All concrete works to be cured to British standard BS

4. All earthworks shall be inspected and approved by Engineer
5. Engineer to inspect reinforcements fixing prior to casting of concrete. FUNDED BY: PHASE DETAILED_STRUCTURAL_DESIGN COVID 19 measures and sanitation project in Mbeya and Tunduma TUNDUMA WATER SUPPLY AND SANITATION AUTHORITY P.O. Box TUNDUMA GIZ P.O.BOX 1519 Dar es salaam Tanzania www.giz.de BORDA Bremen Overseas Research and Development Association I.Y 14 www.borda-africa.or.tz SCALE (AT A3): 8110 ISAF & PGF: Top slab Reinforcements details 24/03/2022

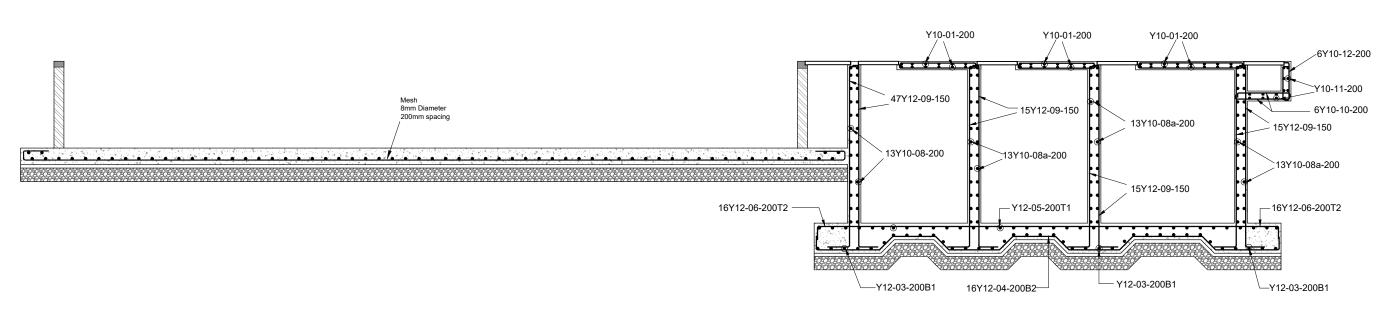

Section A-A

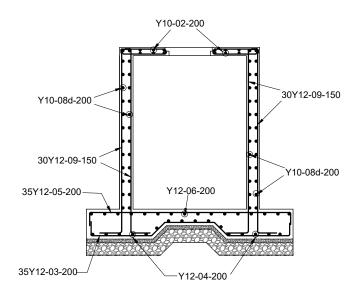

Section C-C

CLIENT:	CONSULTANT:	FUNDED BY:	PROJECT NAME: COVID 19 measures and sanitation project in	NOTES:	LEGEND: ABR - Anaerobic Baffled	DE DOMONI EUVOI	PHASE DETAILS	ED_STRUCTURAL_DESIGN	DRAWING NO.:
TUNDUMA WATER SUPPLY AND SANITATION AUTHORITY P.O. Box	BORDA Bremen Overseas Research and Development Association	GIZ P.O.BOX 1519 Dar es salaam	Mbeya and Tunduma DRAWING TITLE:	In this is the product of BORDA and is not to be copied or reproduced without the permission of BORDA. All dimensions are in [mm] unless otherwise specified. Engineer Engineer to inspect reinforcements fixing prior to	Reactor AF - Anaerobic Filter BGD - Biogas Digester	GL - Ground Level PBL - Pipe Inner Bottom Level	DRAWN:	APPROVED BY:	15
TUNDUMA	www.borda-africa.or.tz	Tanzania www.giz.de ISAF & PGF: GA Sections		All concrete works to be cured to British standard BS casting of concrete. 8110	PGF - Planted Gravel Filter VSF - Vertical Sand Filter	RL - Reference Line WL - Water Level GA - General arrangement	SCALE (AT A3): nent 1:54	DATE: 24/03/2022	

ISAF + PGF Bar Bending schedule

member	Mark	Diameter	Total Numbers/Area	Length (mm)	Unit weight (kg/m)	Total weight (kg)	Bar bending shape
Base	03	Y12	35	3550	0.888	111	
	04	Y12	16	7800	0.888	111	
	05	Y12	35	3350	0.888	105	
	06	Y12	16	7250	0.888	103	
Walls	08	Y10	26	7500	0.616	120	
	08a	Y10	78	2185	0.616	152	
	08Ь	Y12	56	6150	0.888	306	
	08c	Y12	42	1500	0.888	56	
	08d	Y10	52	6100	0.616	196	
	09	Y12	304	3150	0.888	851	
Top slab	01	Y08	60	2185	0.324	43	
	02	Y08	22	6100	0.324	44	
					Total	2,198	

ISAF + PGF BRC mesh

member	Mark	Diameter	Total Numbers/Area	Length (mm)	Unit weight (kg/m)	Total weight (kg)	Bar bending shape
BRC mesh A252 Base slab	01	Y08	92 sqm		3.95	363	

BL - Bottom Level
GL - Ground Level
PBL - Pipe Inner
Bottom Level
RL - Reference Line
WL - Water Level
GA - General arrangement NOTES:
1. This is the product of BORDA and is not to be copied or reproduced without the permission of BORDA.
2. All dimensions are in [mm] unless otherwise specified.
3. All concrete works to be cured to British standard BS

4. All earthworks shall be inspected and approved by Engineer
5. Engineer to inspect reinforcements fixing prior to casting of concrete. LEGEND: CONSULTANT: FUNDED BY: LEGEND:
ABR - Anaerobic Baffled
Reactor
AF - Anaerobic Filter
BGD - Biogas Digester
PGF - Planted Gravel
Filter
VSE - Vertical Sand Filter PHASE DETAILED_STRUCTURAL_DESIGN COVID 19 measures and sanitation project in Mbeya and Tunduma TUNDUMA WATER SUPPLY AND SANITATION AUTHORITY P.O. Box TUNDUMA BORDA Bremen Overseas Research and Development Association GIZ P.O.BOX 1519 Dar es salaam Tanzania www.giz.de APPROVED BY: I.Y 16 DRAWING TITLE: www.borda-africa.or.tz SCALE (AT A3): ISAF & PGF: Bar Bending schedule 24/03/2022 N/A VSF - Vertical Sand Filter



TUNDUMA WATER SUPPLY AND SANITATION AUTHORITY P.O. Box TUNDUMA

BORDA Bremen Overseas Research and Development Association www.borda-africa.or.tz

CONSULTANT:

FUNDED BY: GIZ P.O.BOX 1519 Dar es salaam Tanzania www.giz.de

COVID 19 measures and sanitation project in Mbeya and Tunduma DRAWING TITLE:

SDY SEPARATOR

NOTES:
1. This is the product of BORDA and is not to be copied or reproduced without the permission of BORDA.
2. All dimensions are in [mm] unless otherwise specified.
3. All concrete works to be cured to British standard BS
8110

LEGEND:

ABR - Anaerobic Baffled
Reactor

AF - Anaerobic Filter
BGD - Biogas Digester
PGF - Planted Gravel
Filter
VSE Vottical Sand Filter


VSF - Vertical Sand Filter


BL - Bottom Level GL - Ground Level PBL - Pipe Inner Bottom Level RL - Reference Line WL - Water Level


DRAWING NO.: PHASE DETAILED_STRUCTURAL_DESIGN APPROVED BY: I.Y I.Y 17 SCALE (AT A3):

24/03/2022

1:8

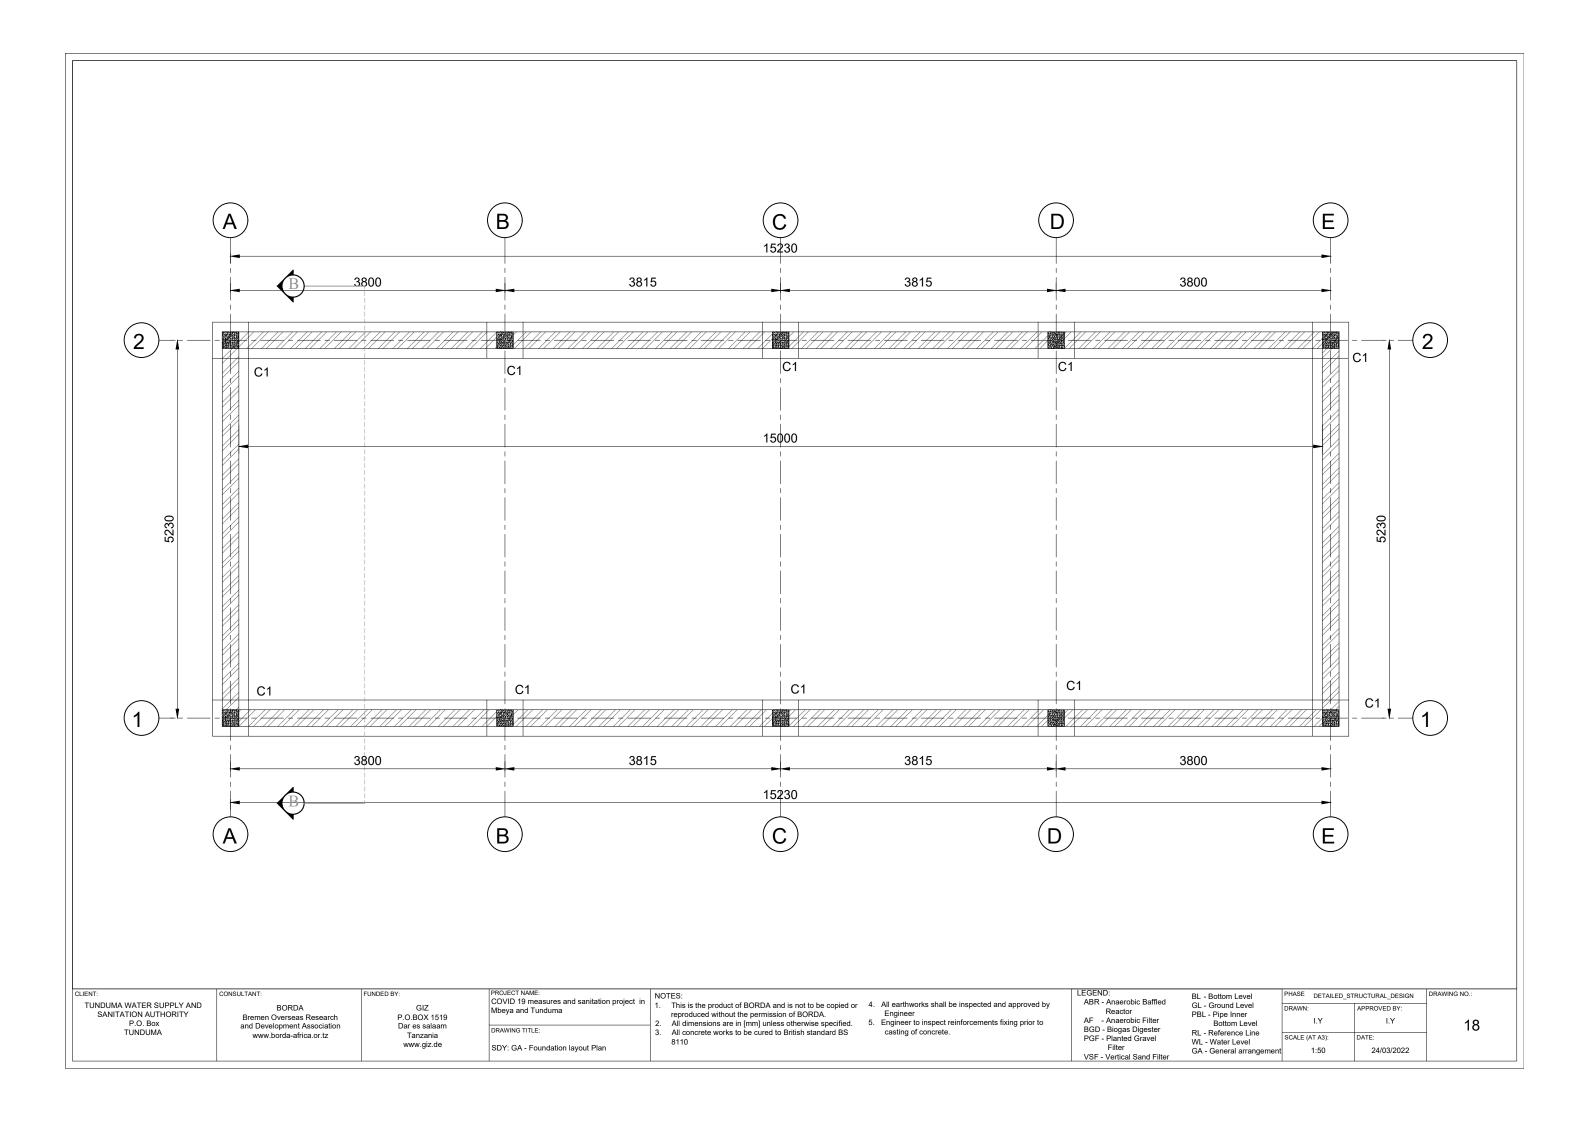

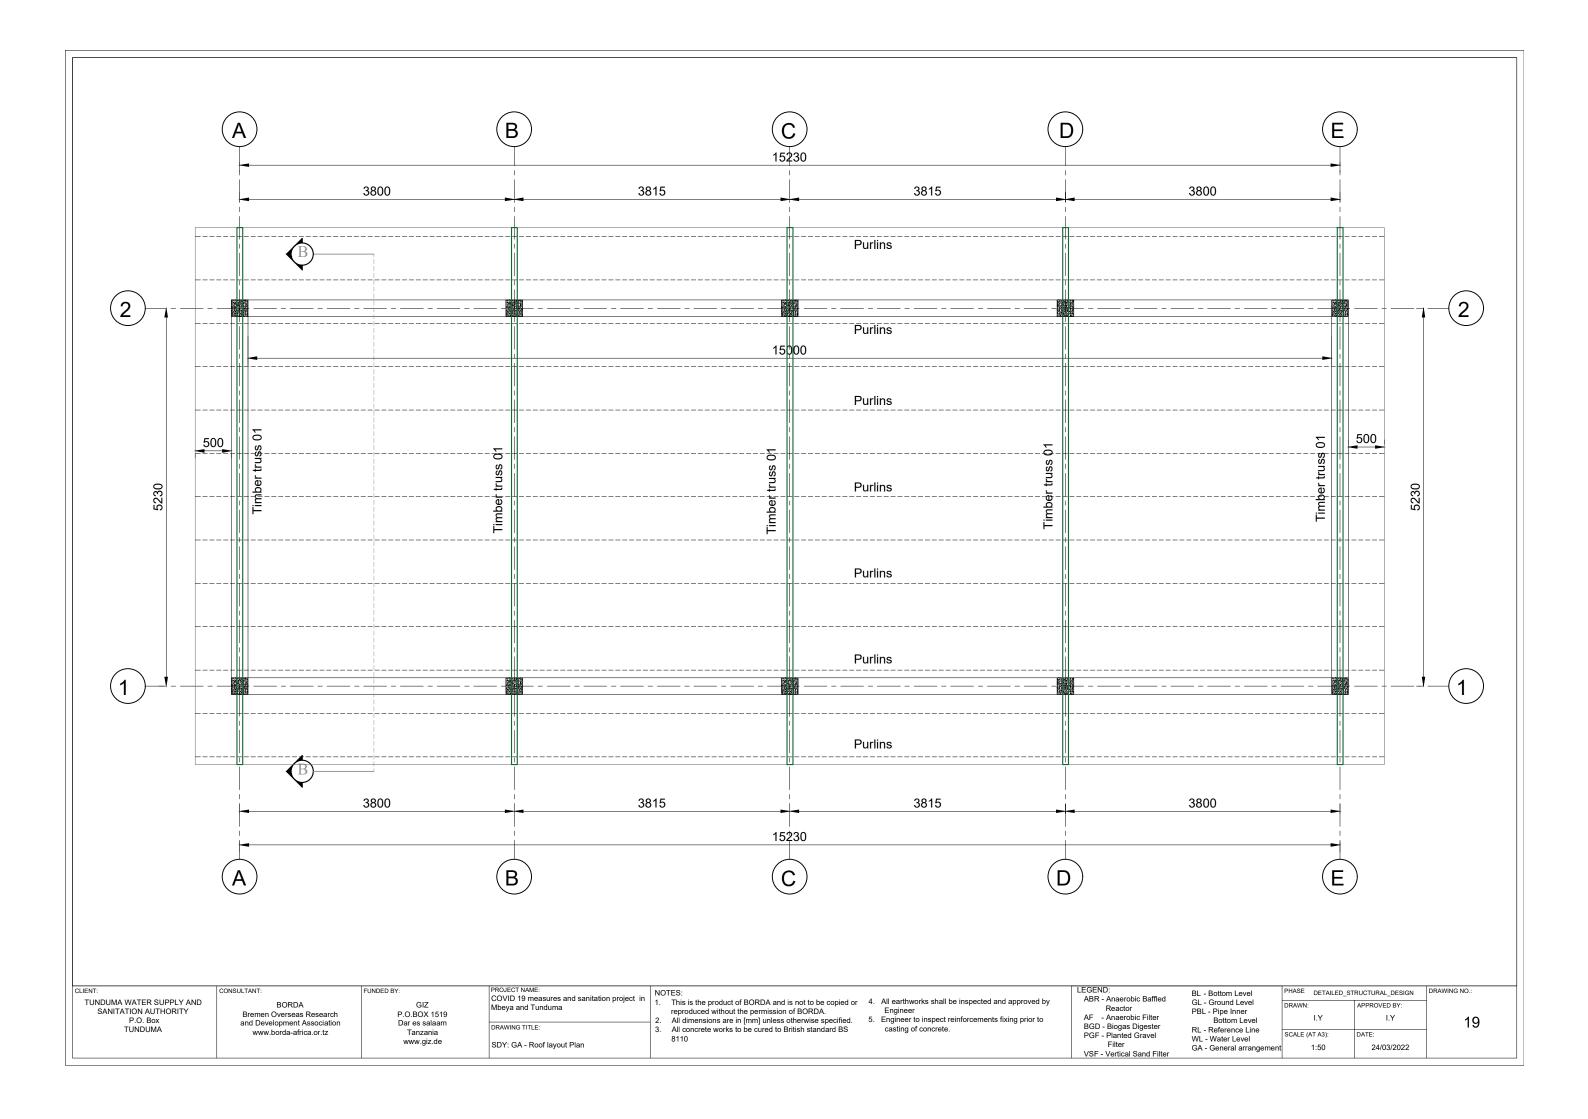

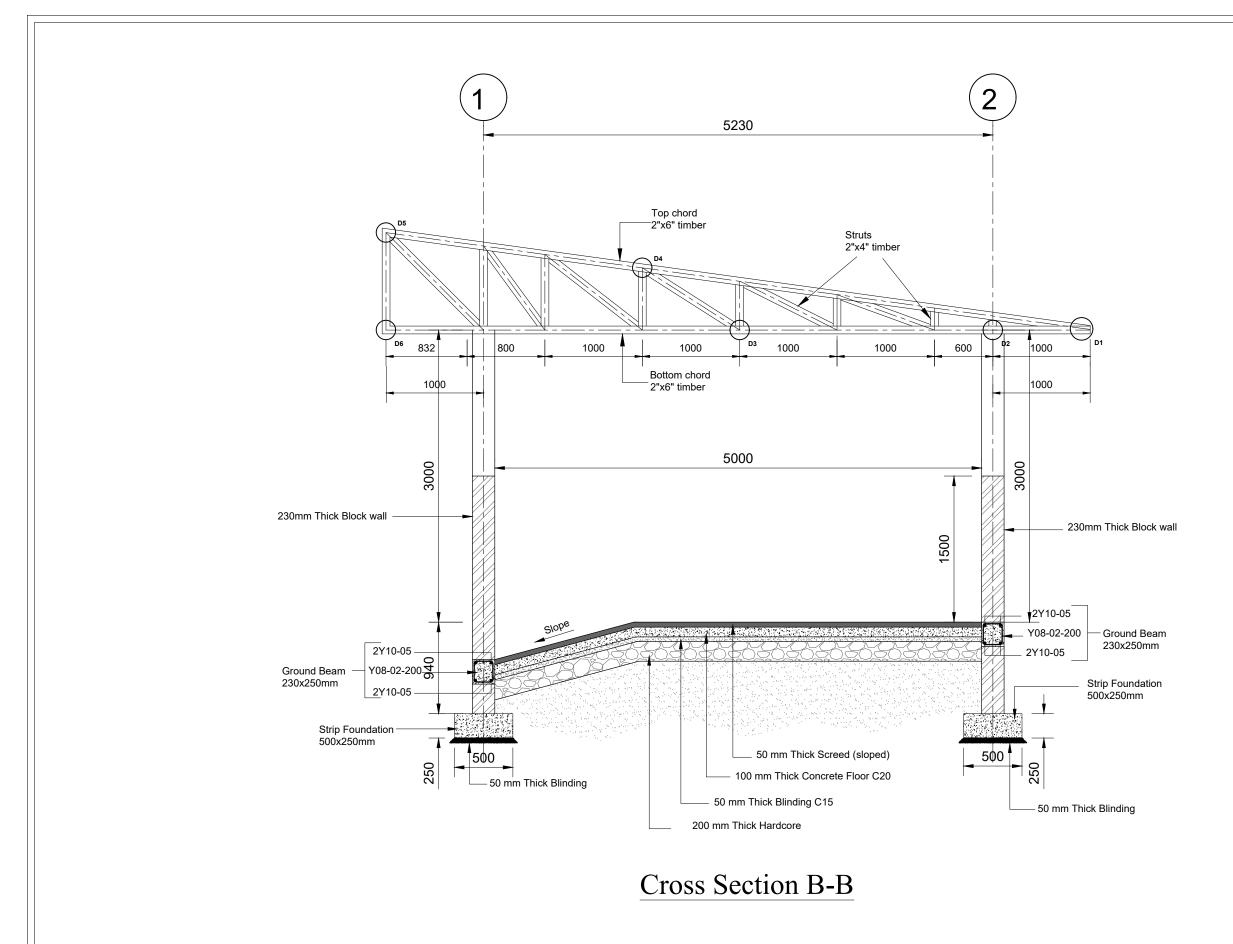


LEGEND: FUNDED BY: BL - Bottom Level
GL - Ground Level
PBL - Pipe Inner
Bottom Level
RL - Reference Line HASE DETAILED_STRUCTURAL_DESIGN ABR - Anaerobic Baffled
Reactor
AF - Anaerobic Filter
BGD - Biogas Digester
PGF - Planted Gravel
Filter
VSE Vertical Spad Filter TUNDUMA WATER SUPPLY AND SANITATION AUTHORITY P.O. Box TUNDUMA COVID 19 measures and sanitation project Mbeya and Tunduma This is the product of BORDA and is not to be copied or reproduced without the permission of BORDA.


All dimensions are in [mm] unless otherwise specified.

All concrete works to be cured to British standard BS


4. All earthworks shall be inspected and approved by Engineer

5. Engineer to inspect reinforcements fixing prior to casting of concrete. BORDA GIZ P.O.BOX 1519 Bremen Overseas Research and Development Association I.Y 20 Dar es salaam Tanzania www.giz.de www.borda-africa.or.tz SCALE (AT A3): WL - Water Level GA - General arrangeme SDY: SECTION B-B details 1:37 24/03/2022 VSF - Vertical Sand Filter

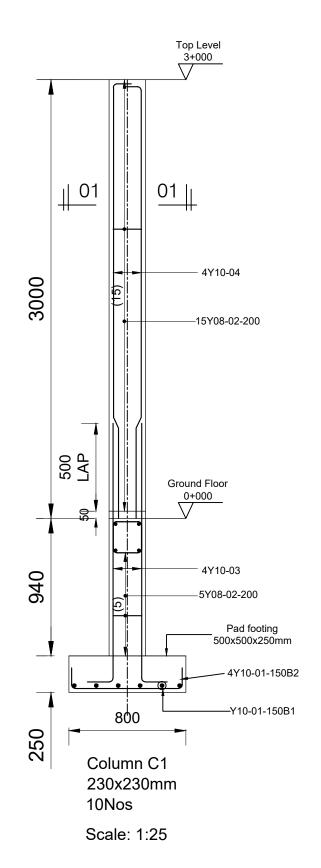

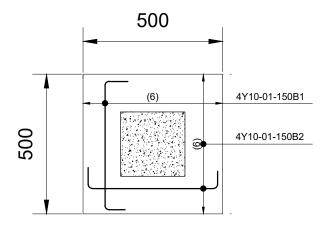

Footing details scale: 1: 13

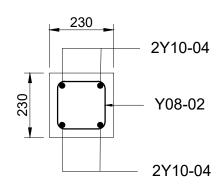

Section 01-01 scale: 1: 13

CLIENT:	
TUNDUMA WATER SUPPLY ANI	D
SANITATION AUTHORITY	
P.O. Box	
TUNDUMA	

BORDA Bremen Overseas Research and Development Association www.borda-africa.or.tz

CONSULTANT

FUNDED BY GIZ P.O.BOX 1519 Dar es salaam Tanzania www.giz.de COVID 19 measures and sanitation project Mbeya and Tunduma

SDY: Columns and Footing details

NOTES:

This is the product of BORDA and is not to be copied or reproduced without the permission of BORDA.

All dimensions are in [mm] unless otherwise specified.

All concrete works to be cured to British standard BS

4. All earthworks shall be inspected and approved by Engineer

5. Engineer to inspect reinforcements fixing prior to casting of concrete.

LEGEND:

ABR - Anaerobic Baffled
Reactor
AF - Anaerobic Filter
BGD - Biogas Digester
PGF - Planted Gravel
Filter
VSE Vertical Spad Filter


VSF - Vertical Sand Filter

BL - Bottom Level
GL - Ground Level
PBL - Pipe Inner
Bottom Level
RL - Reference Line
WL - Water Level
GA - General arrangement PHASE DETAILED_STRUCTURAL_DESIGN APPROVED BY I.Y SCALE (AT A3):

AS_SHOWN

24/03/2022

21

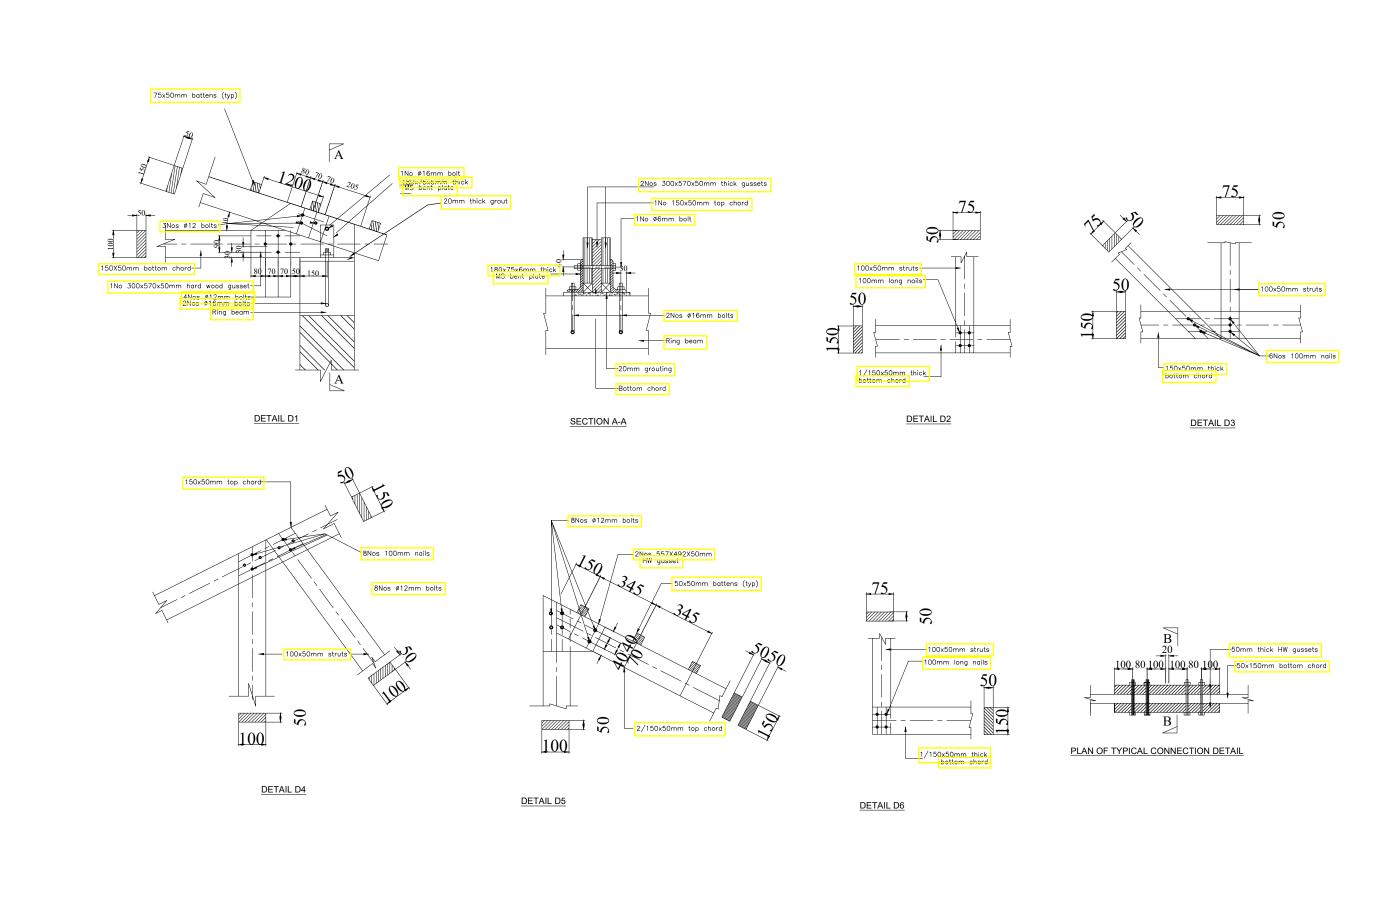

CLIENT: TUNDUMA WATER SUPPLY AND SANITATION AUTHORITY P.O. Box TUNDUMA	CONSULTANT: BORDA Bremen Overseas Research and Development Association www.borda-africa.or.tz	FUNDED BY: GIZ P.O.BOX 1519 Dar es salaam Tanzania www.giz.de	PROJECT NAME: COVID 19 measures and sanitation project in Mbeya and Tunduma DRAWING TITLE: SDY: connection details	NOTES: 1. This is the product of BORDA and is not to be copied or reproduced without the permission of BORDA. 2. All dimensions are in [mm] unless otherwise specified. 3. All concrete works to be cured to British standard BS 8110	LEGEND: ABR - Anaerobic Baffled Reactor AF - Anaerobic Filter BGD - Biogas Digester PGF - Planted Gravel Filter VSF - Vertical Sand Filter	BL - Bottom Level GL - Ground Level PBL - Pipe Inner Bottom Level RL - Reference Line WL - Water Level GA - General arrangemen	DRAWN: I.Y SCALE (AT A3):	APPROVED BY: I.Y DATE: 24/03/2022	DRAWING NO.:
--	--	---	---	---	--	--	----------------------------	--------------------------------------	--------------

SDY Bar Bending schedule

member	Mark	Diameter	Total Numbers/Area	Length (mm)	Unit weight (kg/m)	Total weight (kg)	Bar bending shape
Footing	01	Y10	120	700	0.616	52	
Columns	02	Y08	45	920	0.395	17	
	03	Y10	8	1950	0.616	10	
	04	Y10	40	3100	0.616	77	
Ground beam	05	Y10	16	8700	0.616	86	
	05a	Y10	8	5500	0.616	27	
	02	Y08	204	920	0.395	74	
				Total	343		
BRC mesh A252 G.floor slab	01	Y08	80 sqm		3.95	316	

CLIENT: TUNDUMA WATER SUPPLY AND SANITATION AUTHORITY P.O. Box TUNDUMA TUNDUMA CONSULTANT: BORDA Bremen Overseas Research and Development Association www.borda-africa.or.tz	GIZ COVI Mbey P.O.BOX 1519 Dar es salaam Tanzania	JECT NAME: //ID 19 measures and sanitation project in //ID 19 measur	NOTES: 1. This is the product of BORDA and is not to be copied or reproduced without the permission of BORDA. 2. All dimensions are in [mm] unless otherwise specified. 3. All concrete works to be cured to British standard BS 8110 4. All earthworks shall be inspected and approved by Engineer 5. Engineer to inspect reinforcements fixing prior to casting of concrete.	LEGEND: ABR - Anaerobic Baffled Reactor AF - Anaerobic Filter BGD - Biogas Digester PGF - Planted Gravel Filter VSF - Vertical Sand Filter	GL - Bottom Level PBL - Pipe Inner Bottom Level	DRAWN:	RUCTURAL_DESIGN APPROVED BY: I.Y DATE: 24/03/2022	DRAWING NO.:
---	---	--	---	--	---	--------	---	--------------



TUNDUMA WATER SUPPLY AND SANITATION AUTHORITY P.O. Box TUNDUMA

BORDA
Bremen Overseas Research
and Development Association
www.borda-africa.or.tz

CONSULTANT:

FUNDED BY: GIZ P.O.BOX 1519 Dar es salaam Tanzania www.giz.de

PROJECT NAME: COVID 19 measures and sanitation project in Mbeya and Tunduma DRAWING TITLE:

SSY SEPARATOR

NOTES:
1. This is the product of BORDA and is not to be copied or reproduced without the permission of BORDA.
2. All dimensions are in [mm] unless otherwise specified.
3. All concrete works to be cured to British standard BS
8110

LEGEND:

ABR - Anaerobic Baffled
Reactor


AF - Anaerobic Filter
BGD - Biogas Digester
PGF - Planted Gravel
Filter
VSE Vottical Sand Filter


VSF - Vertical Sand Filter


BL - Bottom Level GL - Ground Level PBL - Pipe Inner Bottom Level RL - Reference Line WL - Water Level


PHASE DETAILED_STRUCTURAL_DESIGN APPROVED BY:


I.Y I.Y 24 SCALE (AT A3): 1:8 24/03/2022

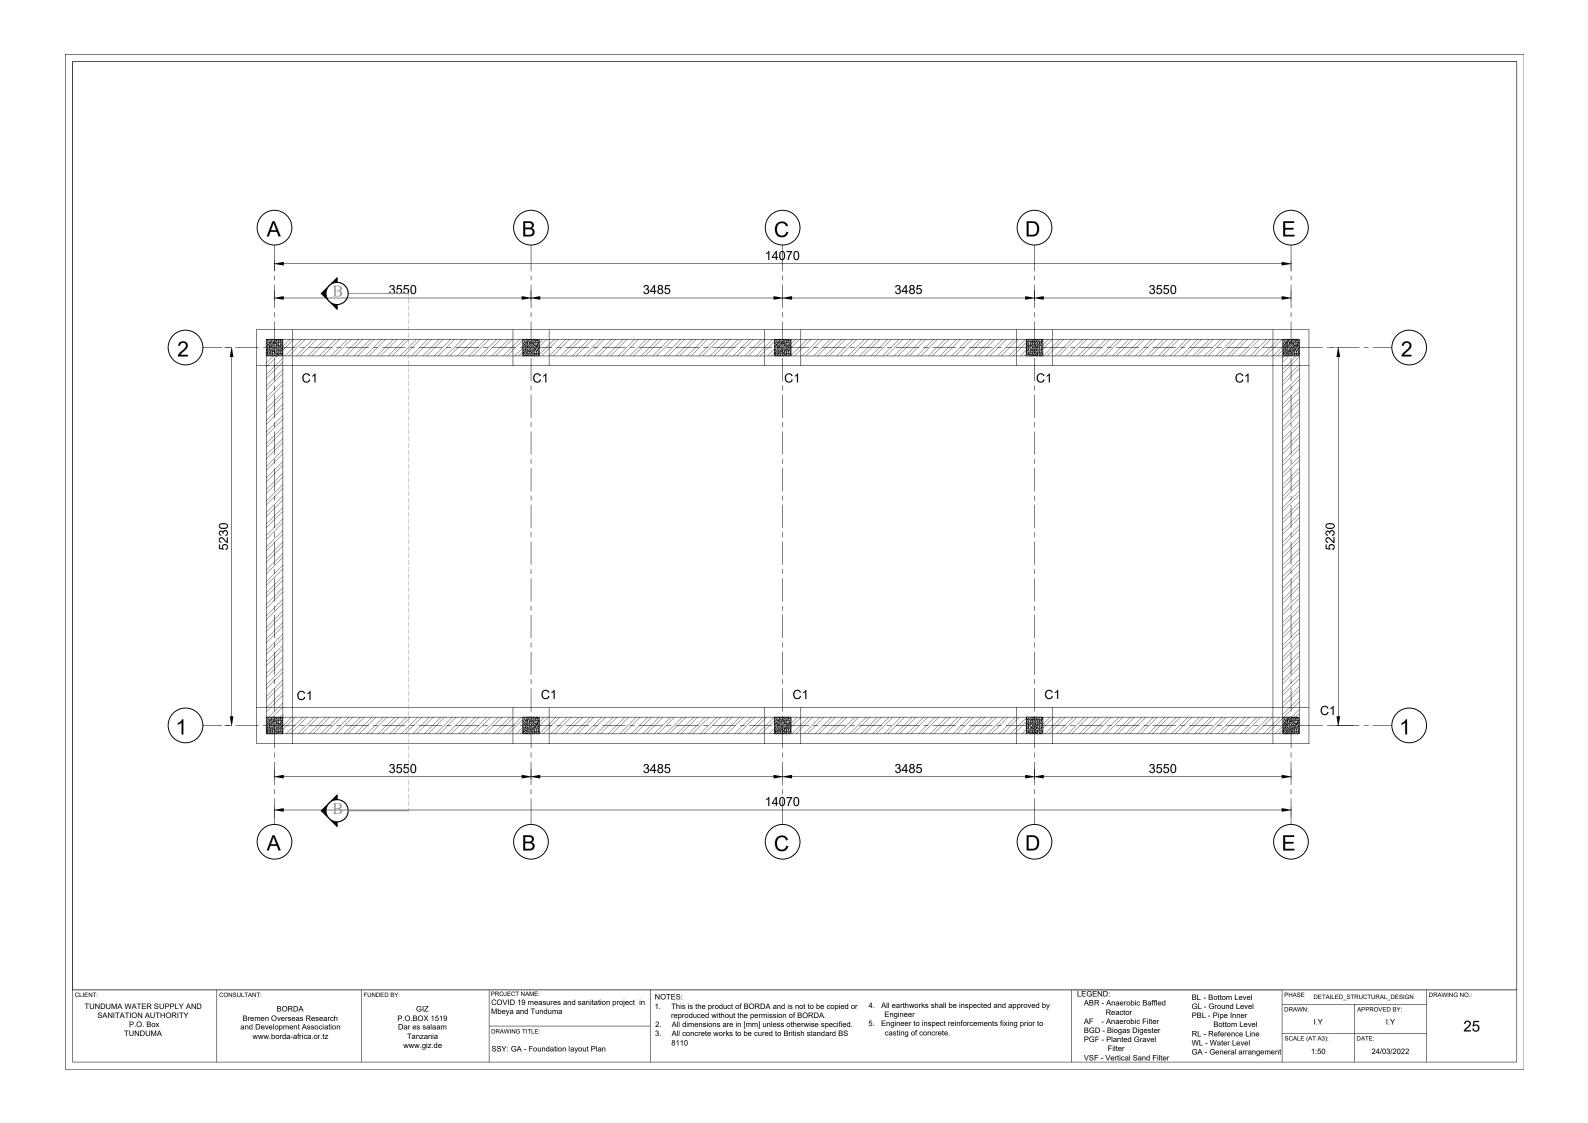

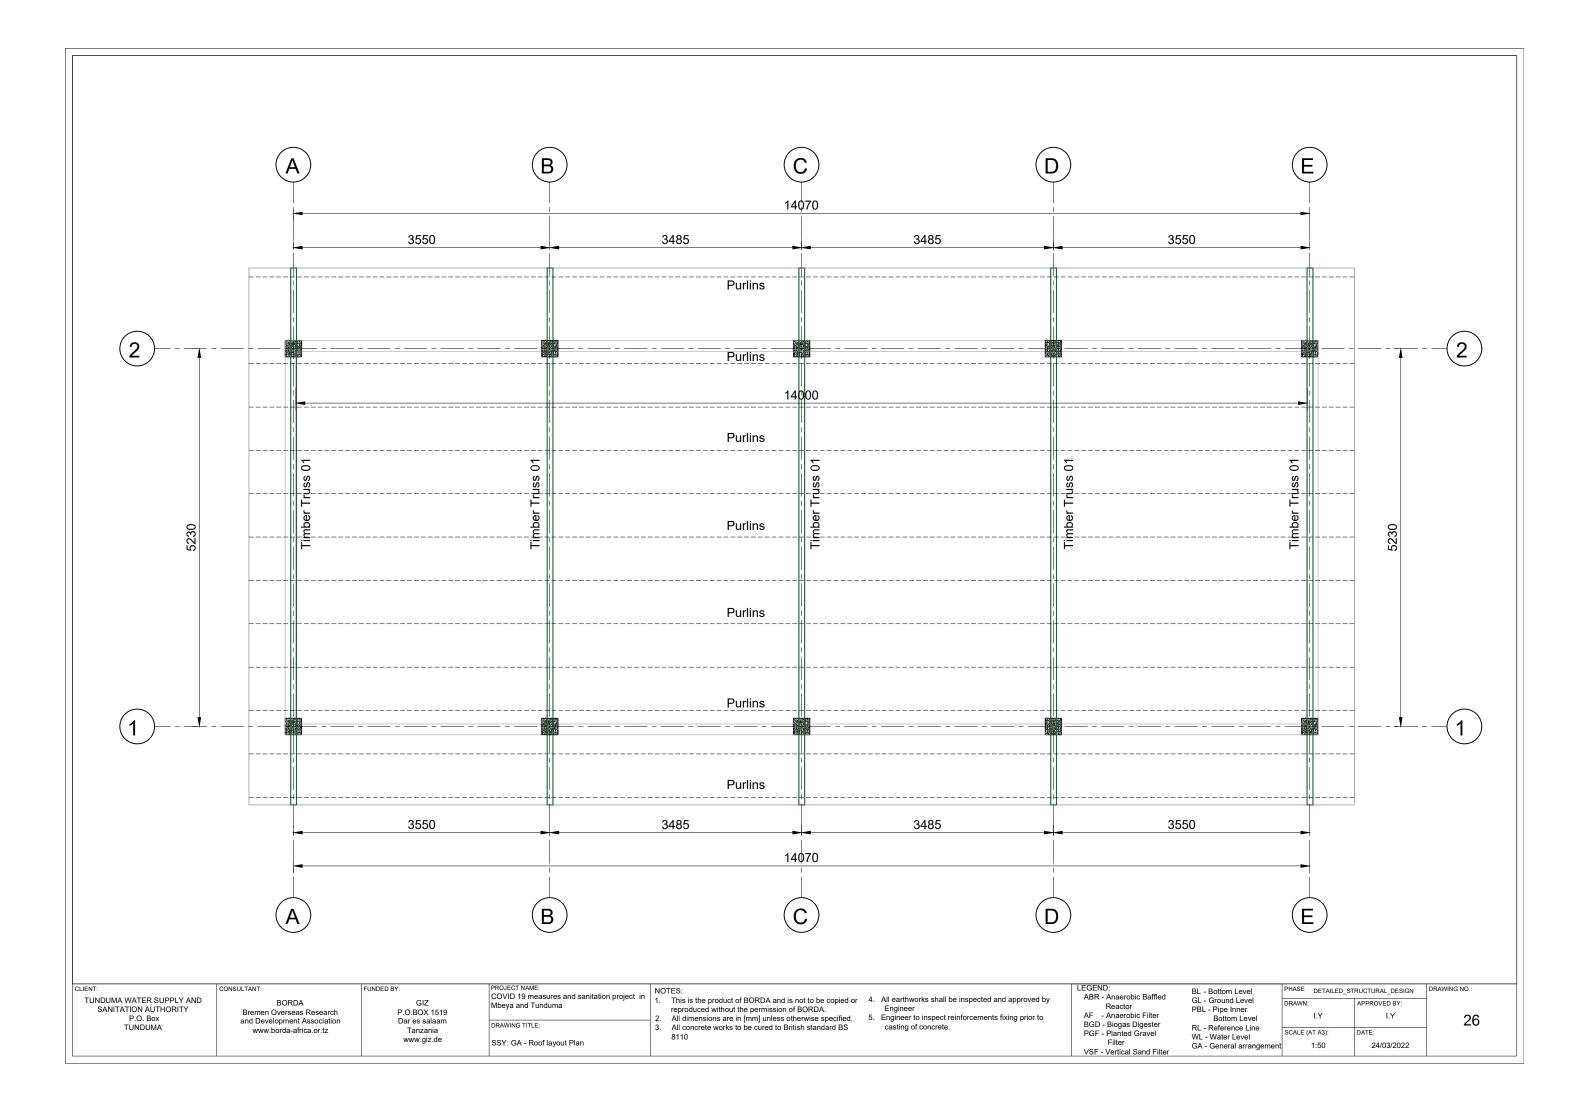


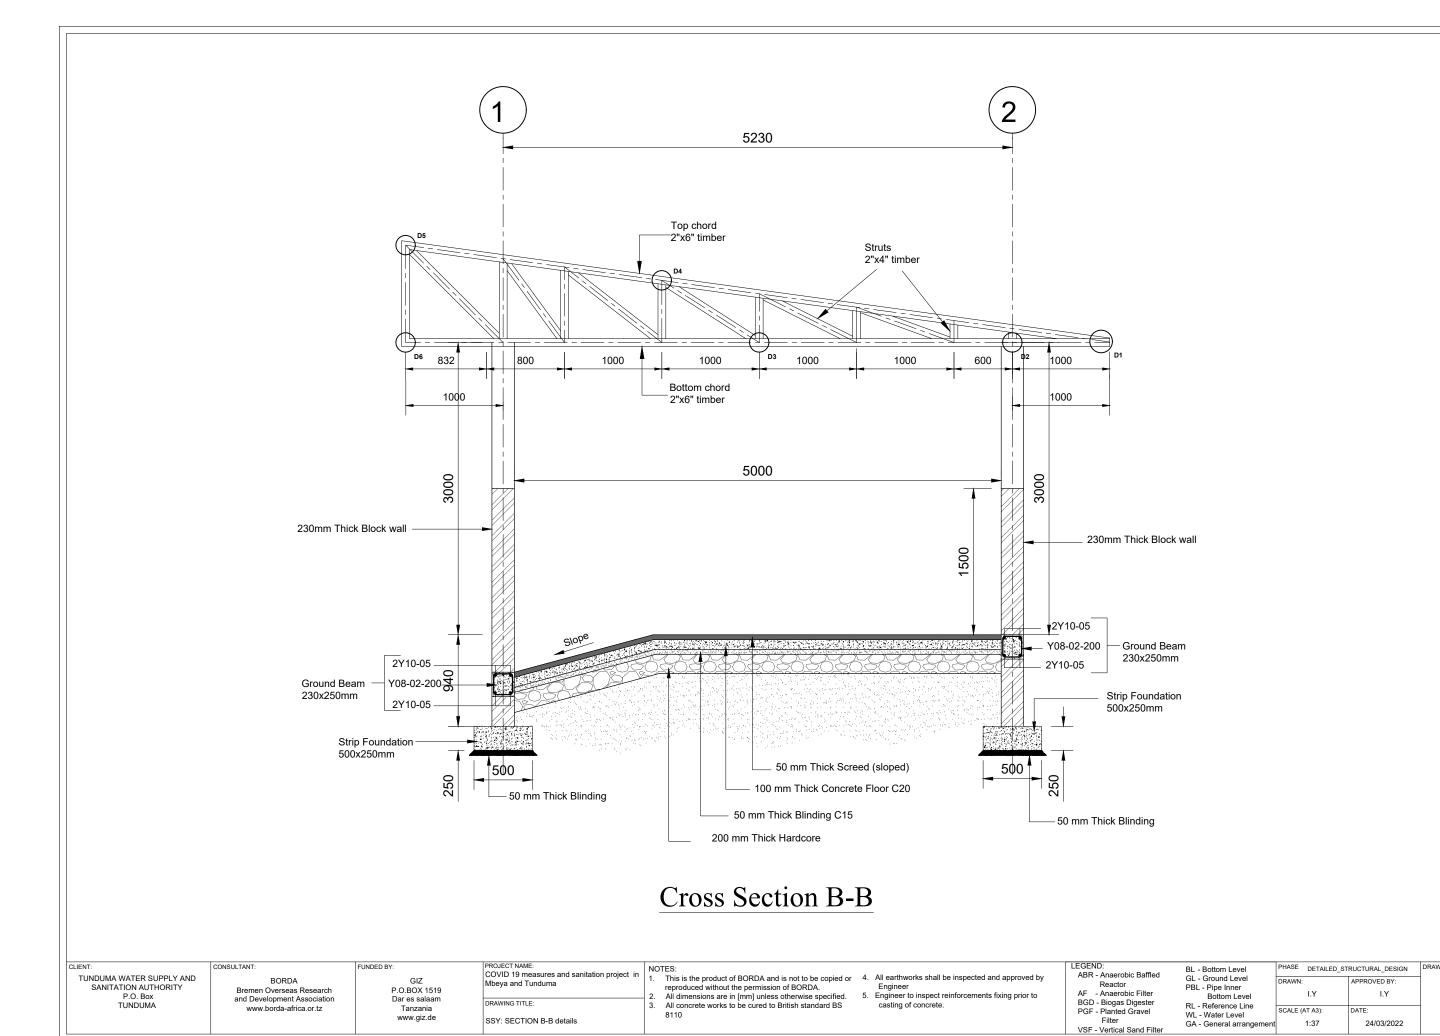

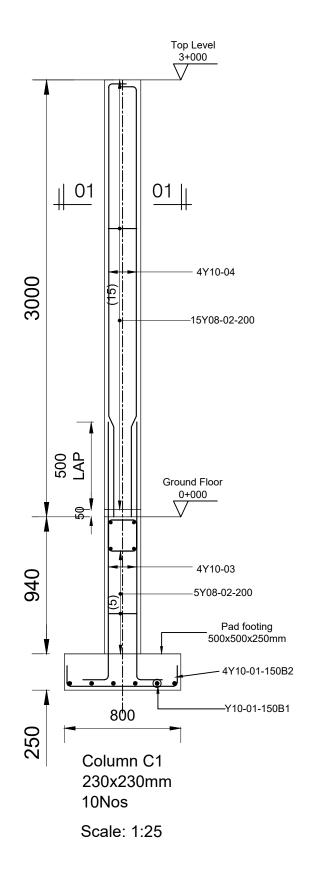

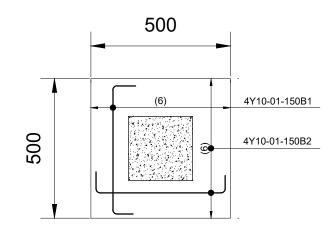

Footing details

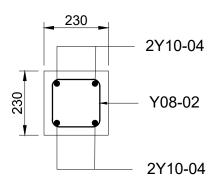

Section 01-01 scale: 1: 13

CLIENT:	
TUNDUMA WATER SUPPLY AND	
SANITATION AUTHORITY	
P.O. Box	
TUNDUMA	

CONSULTANT: BORDA Bremen Overseas Research and Development Association www.borda-africa.or.tz

FUNDED BY: COVID 19 measures and sanitation project i Mbeya and Tunduma GIZ P.O.BOX 1519 Dar es salaam Tanzania www.giz.de SSY: Columns and Footing details

NOTES:

This is the product of BORDA and is not to be copied or reproduced without the permission of BORDA.

All dimensions are in [mm] unless otherwise specified.

All concrete works to be cured to British standard BS

4. All earthworks shall be inspected and approved by Engineer

5. Engineer to inspect reinforcements fixing prior to casting of concrete.

LEGEND:

ABR - Anaerobic Baffled
Reactor
AF - Anaerobic Filter
BGD - Biogas Digester
PGF - Planted Gravel
Filter
VSE Vertical Spad Filter

VSF - Vertical Sand Filter


BL - Bottom Level
GL - Ground Level
PBL - Pipe Inner
Bottom Level
RL - Reference Line
WL - Water Level
GA - General arrangement I.Y SCALE (AT A3):

AS_SHOWN

HASE DETAILED_STRUCTURAL_DESIGN APPROVED BY

24/03/2022

28

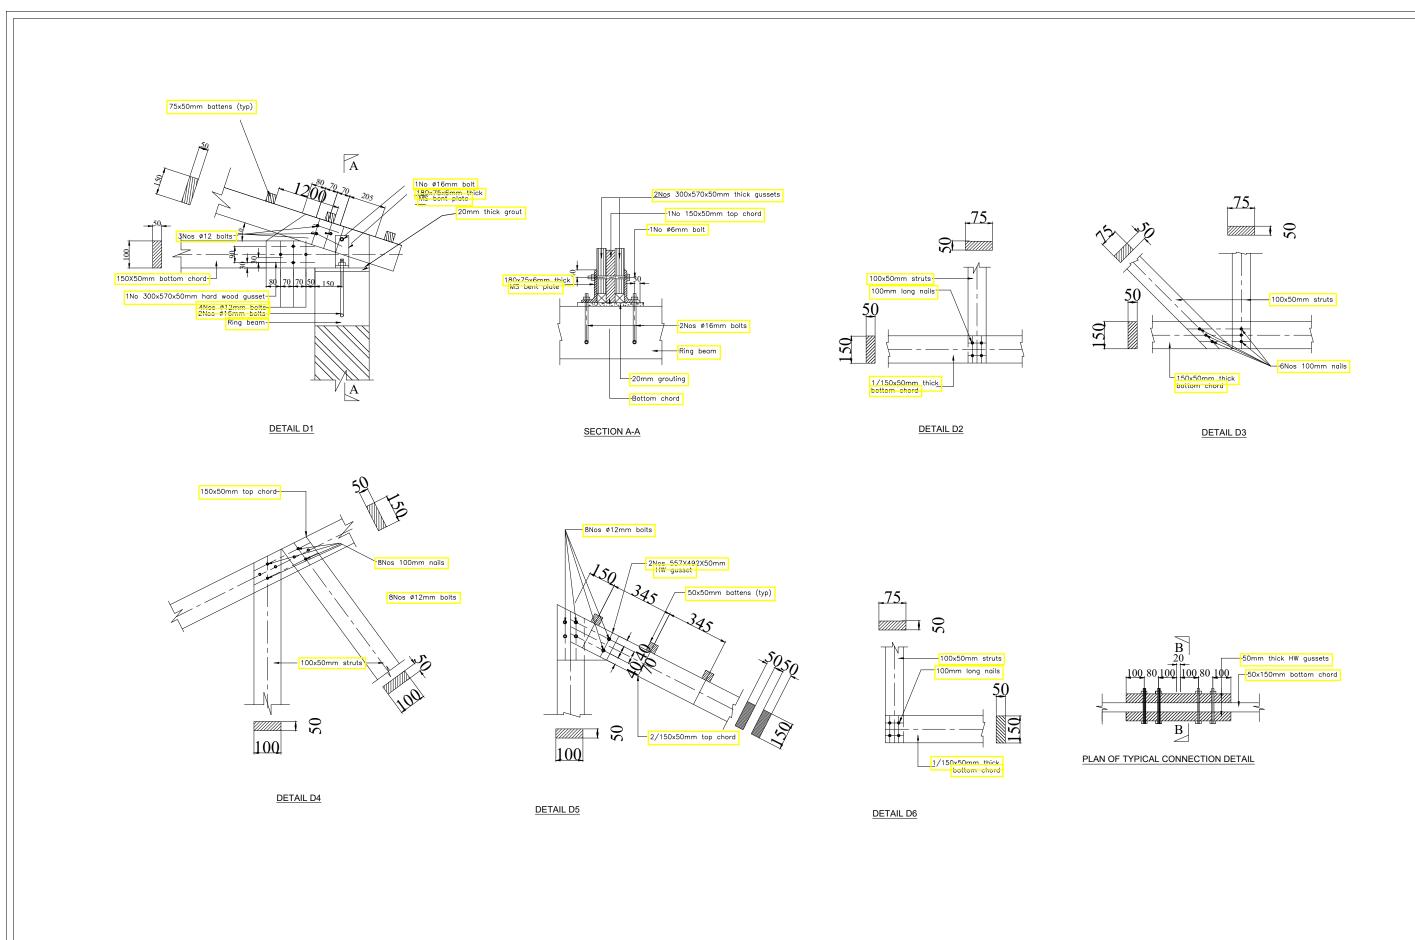

CLIENT:	CONSULTANT:	FUNDED BY:	PROJECT NAME: COVID 19 measures and sanitation project in	NOTES:	LEGEND: ABR - Anaerobic Baffled		PHASE DETAILED_ST	TRUCTURAL_DESIGN	DRAWING NO.:
TUNDUMA WATER SUPPLY AND SANITATION AUTHORITY	BORDA Bremen Overseas Research	GIZ P.O.BOX 1519	Mbeya and Tunduma	This is the product of BORDA and is not to be copied or reproduced without the permission of BORDA. But earthworks shall be inspected and approved by Engineer.	Reactor	GL - Ground Level PBL - Pipe Inner	DRAWN:	APPROVED BY:	
P.O. Box	and Development Association	Dar es salaam	DRAWING TITLE:	All dimensions are in [mm] unless otherwise specified. All concrete works to be cured to British standard BS Casting of concrete.	AF - Anaerobic Filter BGD - Biogas Digester	Bottom Level RL - Reference Line	I.Y	I.Y	29
TUNDUMA www.borda-africa.or.tz	Tanzania		8110	PGF - Planted Gravel	WL - Water Level	SCALE (AT A3):	DATE:		
			SSY: connection details		VSF - Vertical Sand Filter	GA - General arrangemen	1:20	24/03/2022	

SSY Bar Bending schedule

member	Mark	Diameter	Total Numbers/Area	Length (mm)	Unit weight (kg/m)	Total weight (kg)	Bar bending shape
Footing	01	Y10	120	700	0.616	52	
Columns	02	Y08	45	920	0.395	17	
	03	Y10	8	1950	0.616	10	
	04	Y10	40	3100	0.616	77	
Ground beam	05	Y10	16	7500	0.616	74	L
	05a	Y10	8	5500	0.616	27	
	02	Y08	192	920	0.395	70	
					Total	327	
BRC mesh A252 G.floor slab	01	Y08	73 sqm		3.95	289	

CLIENT:	CONSULTANT:	FUNDED BY:	PROJECT NAME: COVID 19 measures and sanitation project in	NOTES:	LEGEND: ABR - Anaerobic Baffled	BL - Bottom Level	PHASE DETAILED_ST	RUCTURAL_DESIGN	DRAWING NO.:
TUNDUMA WATER SUPPLY AND SANITATION AUTHORITY P.O. Box	BORDA Bremen Overseas Research and Development Association	GIZ P.O.BOX 1519 Dar es salaam	Mbeya and Tunduma	This is the product of BURDA and is not to be copied or reproduced without the permission of BORDA. All dimensions are in [mm] unless otherwise specified. Engineer to inspect reinforcements fixing prior to	Reactor AF - Anaerobic Filter	GL - Ground Level PBL - Pipe Inner Bottom Level	DRAWN:	APPROVED BY:	30
TUNDUMA www.borda-africa.or.tz	Tanzania www.giz.de	DRAWING TITLE: SSY: Bar Bending Schedule	All concrete works to be cured to British standard BS casting of concrete. 8110	BGD - Biogas Digester PGF - Planted Gravel Filter VSF - Vertical Sand Filter	RL - Reference Line WL - Water Level GA - General arrangement		DATE: 24/03/2022		



LIENT: TUNDUMA WATER SUPPLY AND SANITATION AUTHORITY P.O. Box TUNDUMA

CONSULTANT:

FUNDED BY: BORDA
Bremen Overseas Research
and Development Association
www.borda-africa.or.tz GIZ P.O.BOX 1519 Dar es salaam Tanzania www.giz.de

PROJECT NAME: COVID 19 measures and sanitation project in Mbeya and Tunduma DRAWING TITLE:

OR SEPARATOR

NOTES:
1. This is the product of BORDA and is not to be copied or reproduced without the permission of BORDA.
2. All dimensions are in [mm] unless otherwise specified.
3. All concrete works to be cured to British standard BS 8110

LEGEND:
ABR - Anaerobic Baffled
Reactor
AF - Anaerobic Filter
BGD - Biogas Digester
PGF - Planted Gravel
Filter
VSF - Vertical Sand Filter


BL - Bottom Level GL - Ground Level PBL - Pipe Inner Bottom Level RL - Reference Line WL - Water Level


PHASE DETAILED_STRUCTURAL_DESIGN I.Y SCALE (AT A3):

1:8

APPROVED BY: I.Y 31 24/03/2022

DRAWING NO.:

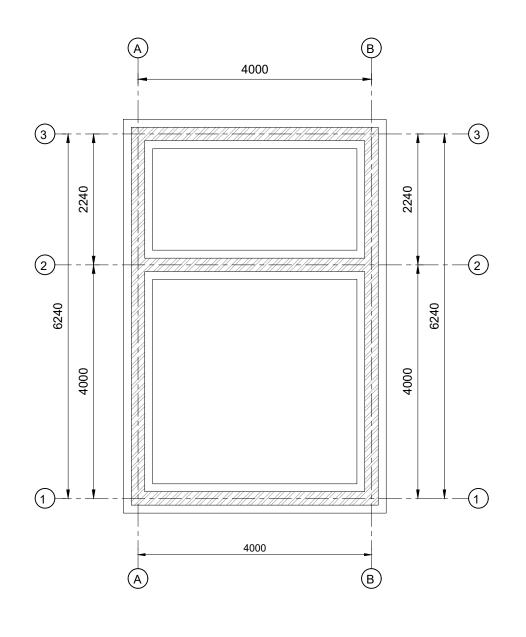


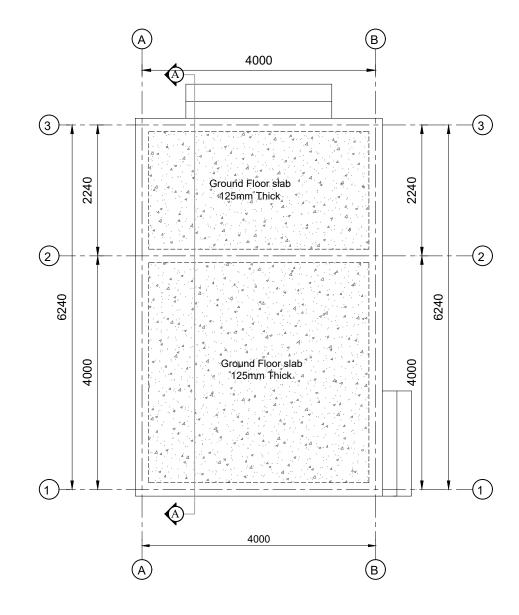


Foundation Layout Plan

Ground Floor Layout Plan


CLIENT:	CONSULTANT:	FUNDED BY:	PROJECT NAME: COVID 19 measures and sanitation project in	NOTES:	LEGEND: ABR - Anaerobic Baffled	DE DOMONI EUVOI	PHASE DETAILED_S	TRUCTURAL_DESIGN	DRAWING NO.:
TUNDUMA WATER SUPPLY AND SANITATION AUTHORITY P.O. Box	BORDA Bremen Overseas Research	GIZ P.O.BOX 1519	Mbeya and Tunduma	This is the product of BORDA and is not to be copied or reproduced without the permission of BORDA. All dimensions are in fmml unless otherwise specified. Engineer to inspect reinforcements fixing prior to	Reactor AF - Anaerobic Filter	GL - Ground Level PBL - Pipe Inner Bottom Level	DRAWN:	APPROVED BY:	20
TUNDUMA and Development Association www.borda-africa.or.tz	Tanzania	DRAWING TITLE: OR: GA - Foundation and Ground floor	3. All concrete works to be cured to British standard BS casting of concrete.	BGD - Biogas Digester PGF - Planted Gravel	PI - Reference Line	SCALE (AT A3):	DATE:	32	
			layout Plan		VSF - Vertical Sand Filter	GA - General arrangement	1:62	24/03/2022	

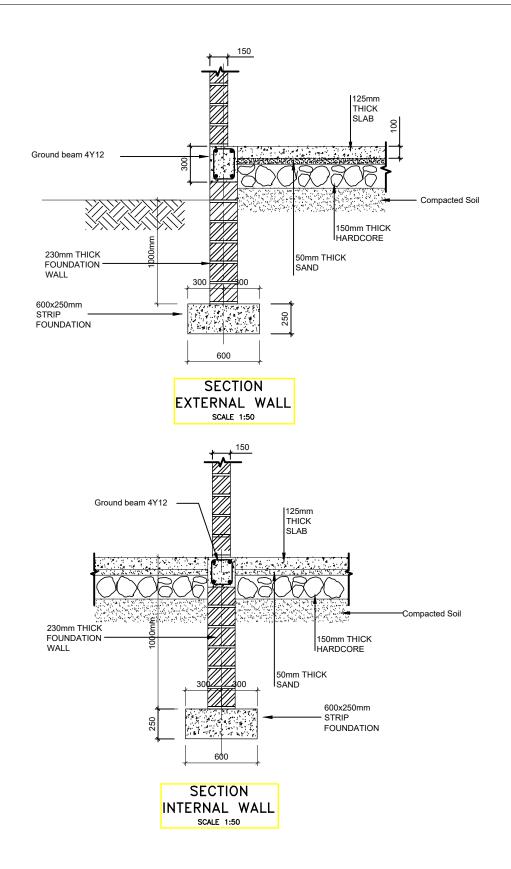

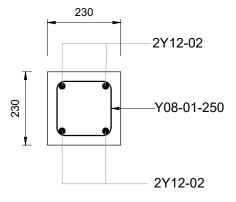

Ground beam typical section

scale: 1:25

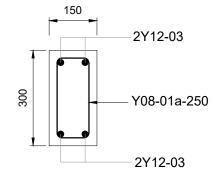


Ring beam typical section


scale: 1:25

Foundation section details

LEGEND: FUNDED BY: BL - Bottom Level
GL - Ground Level
PBL - Pipe Inner
Bottom Level
RL - Reference Line HASE DETAILED_STRUCTURAL_DESIGN UIES:
This is the product of BORDA and is not to be copied or reproduced without the permission of BORDA.
All dimensions are in [mm] unless otherwise specified.
All concrete works to be cured to British standard BS

4. All earthworks shall be inspected and approved by Engineer
5. Engineer to inspect reinforcements fixing prior to casting of concrete. ABR - Anaerobic Baffled Reactor AF - Anaerobic Filter BGD - Biogas Digester PGF - Planted Gravel TUNDUMA WATER SUPPLY AND SANITATION AUTHORITY P.O. Box TUNDUMA COVID 19 measures and sanitation project Mbeya and Tunduma GIZ P.O.BOX 1519 BORDA APPROVED BY Bremen Overseas Research and Development Association I.Y I.Y 33 Dar es salaam Tanzania www.giz.de DRAWING TITLE: www.borda-africa.or.tz SCALE (AT A3): OR: Foundation and Beam section Details WL - Water Level GA - General arrangem AS_SHOWN 24/03/2022 VSF - Vertical Sand Filter

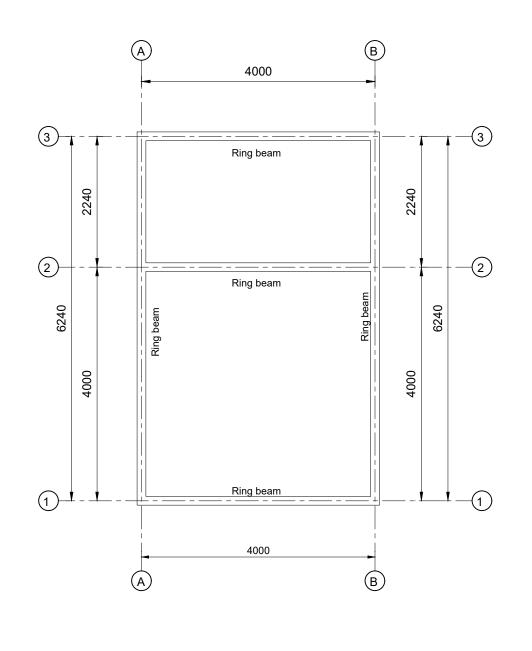


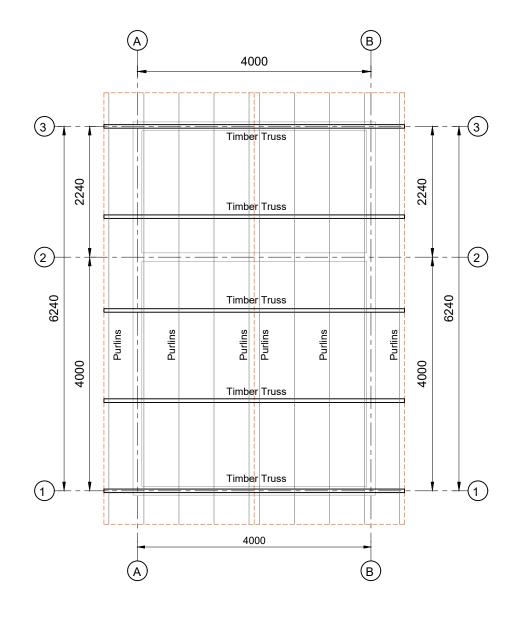

Ring beams Layout Plan

Roof Layout Plan

CLIENT: TUNDUMA WATER SUPPLY AND SANITATION AUTHORITY P.O. Box TUNDUMA	CONSULTANT: BORDA Bremen Overseas Research and Development Association www.borda-africa.or.tz	FUNDED BY: GIZ P.O.BOX 1519 Dar es salaam Tanzania www.giz.de	PROJECT NAME: COVID 19 measures and sanitation project in Mbeya and Tunduma DRAWING TITLE: OR: GA - Columns and Beams layout Plan	NOTES: 1. This is the product of BORDA and is not to be copied or reproduced without the permission of BORDA. 2. All dimensions are in [mm] unless otherwise specified. 3. All concrete works to be cured to British standard BS 8110	LEGEND: ABR - Anaerobic Baffled Reactor AF - Anaerobic Filter BGD - Biogas Digester PGF - Planted Gravel Filter VSF - Vertical Sand Filter	BL - Bottom Level GL - Ground Level PBL - Pipe Inner Bottom Level RL - Reference Line WL - Water Level GA - General arrangemer	DRAWN: I.Y SCALE (AT A3):	D_STRUCTURAL_DESIGN APPROVED BY: I.Y DATE: 24/03/2022	DRAWING NO.:
--	---	---	--	---	--	--	----------------------------	---	--------------

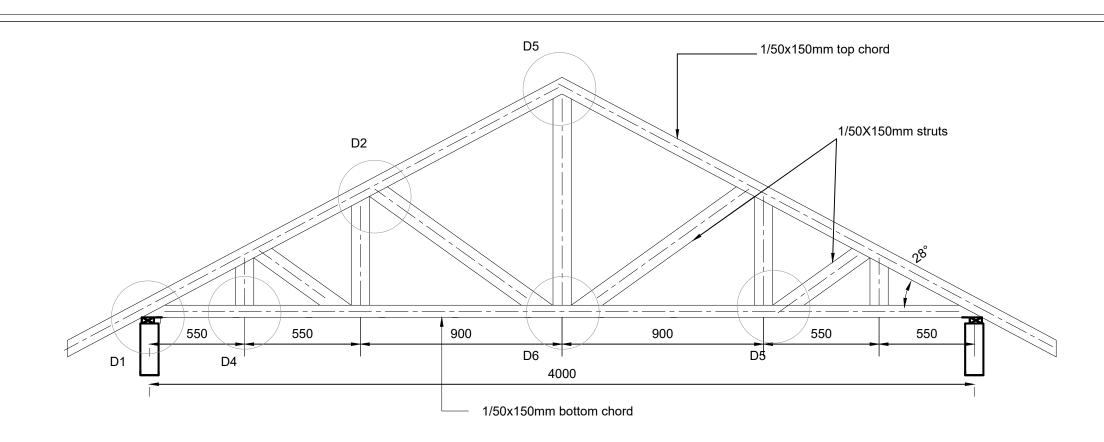

Typical Timber Truss

FUNDED BY:

GIZ P.O.BOX 1519

Dar es salaam

Tanzania www.giz.de

BORDA

Bremen Overseas Research and Development Association


www.borda-africa.or.tz

COVID 19 measures and sanitation project Mbeya and Tunduma

DRAWING TITLE:

OR: Timber truss details

TUNDUMA WATER SUPPLY AND SANITATION AUTHORITY P.O. Box TUNDUMA

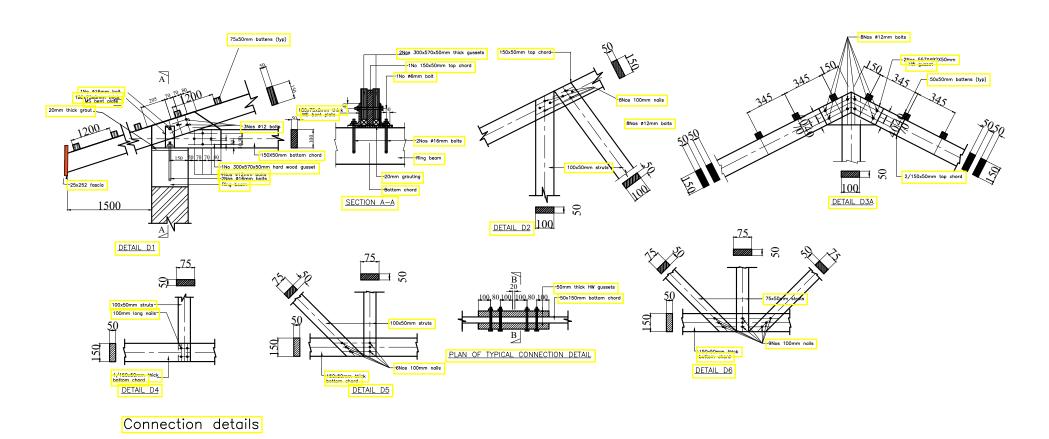

This is the product of BORDA and is not to be copied or reproduced without the permission of BORDA.

All dimensions are in [mm] unless otherwise specified.

All concrete works to be cured to British standard BS

4. All earthworks shall be inspected and approved by Engineer

5. Engineer to inspect reinforcements fixing prior to casting of concrete.

BL - Bottom Level
GL - Ground Level
PBL - Pipe Inner
Bottom Level
RL - Reference Line

WL - Water Level
GA - General arrangemen

ABR - Anaerobic Baffled

Reactor

AF - Anaerobic Filter BGD - Biogas Digester PGF - Planted Gravel

VSF - Vertical Sand Filter

HASE DETAILED_STRUCTURAL_DESIGN

24/03/2022

SCALE (AT A3):

1:30

35

OR Bar Bending schedule

member	Mark	Diameter	Total Numbers/Area	Length (mm)	Unit weight (kg/m)	Total weight (kg)	Bar bending shape
Ground beam	02	Y12	12	4400	0.888	47	
	02a	Y12	8	6700	0.888	48	
	01	Y08	123	920	0.395	45	
Ring beam	03	Y12	12	4400	0.888	47	
	03a	Y12	8	6700	0.888	48	
	01a	Y08	123	1040	0.395	51	
			Total			286	
BRC mesh A252 G.floor slab	01	Y08	36 sqm		3.95	143	

LEGEND:
ABR - Anaerobic Baffled
Reactor
AF - Anaerobic Filter
BGD - Biogas Digester
PGF - Planted Gravel
Filter
VSF - Vertical Sand Filter NOTES:
1. This is the product of BORDA and is not to be copied or reproduced without the permission of BORDA.
2. All dimensions are in [mm] unless otherwise specified.
3. All concrete works to be cured to British standard BS 8110 BL - Bottom Level
GL - Ground Level
PBL - Pipe Inner
Bottom Level
RL - Reference Line
WL - Water Level
GA - General arrangement CONSULTANT: FUNDED BY: PHASE DETAILED_STRUCTURAL_DESIGN LIENT: TUNDUMA WATER SUPPLY AND SANITATION AUTHORITY P.O. Box TUNDUMA COVID 19 measures and sanitation project in Mbeya and Tunduma BORDA
Bremen Overseas Research
and Development Association
www.borda-africa.or.tz APPROVED BY: I.Y I.Y 36 DRAWING TITLE: SCALE (AT A3): OR: Bar Bending Schedule N/A 24/03/2022

LIENT: TUNDUMA WATER SUPPLY AND SANITATION AUTHORITY P.O. Box TUNDUMA

BORDA
Bremen Overseas Research
and Development Association
www.borda-africa.or.tz

CONSULTANT:

FUNDED BY: GIZ P.O.BOX 1519 Dar es salaam Tanzania www.giz.de

PROJECT NAME: COVID 19 measures and sanitation project in Mbeya and Tunduma DRAWING TITLE:

CT SEPARATOR


NOTES:
1. This is the product of BORDA and is not to be copied or reproduced without the permission of BORDA.
2. All dimensions are in [mm] unless otherwise specified.
3. All concrete works to be cured to British standard BS 8110


LEGEND:
ABR - Anaerobic Baffled
Reactor
AF - Anaerobic Filter
BGD - Biogas Digester
PGF - Planted Gravel
Filter
VSF - Vertical Sand Filter

BL - Bottom Level GL - Ground Level PBL - Pipe Inner Bottom Level RL - Reference Line WL - Water Level

DRAWING NO.: PHASE DETAILED_STRUCTURAL_DESIGN APPROVED BY:


I.Y I.Y 37 SCALE (AT A3): 1:8 24/03/2022

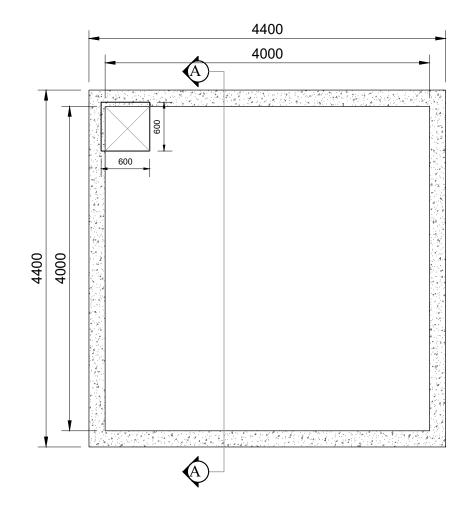


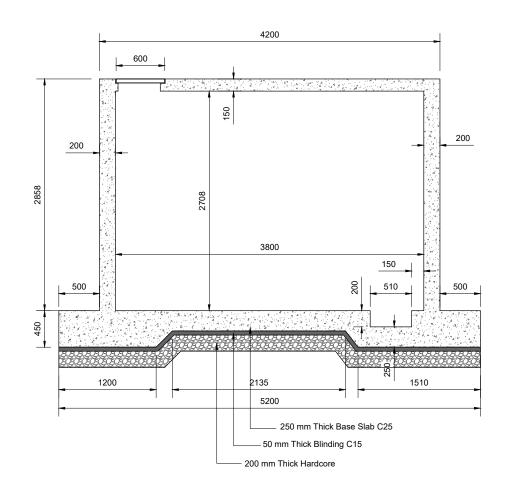

Walls layout plan Section A-A

CLIENT:	CONSULTANT:	FUNDED BY:	PROJECT NAME: COVID 19 measures and sanitation project in	NOTES:	LEGEND: ABR - Anaerobic Baffled	DE DOMONI EOVO	PHASE DETAILED_S	TRUCTURAL_DESIGN	DRAWING NO.:
TUNDUMA WATER SUPPLY AND SANITATION AUTHORITY	BORDA Bremen Overseas Research	GIZ P.O.BOX 1519	Mbeya and Tunduma	 This is the product of BORDA and is not to be copied or reproduced without the permission of BORDA. All dimensions are in [mm] unless otherwise specified. Engineer to inspect reinforcements fixing prior to 	Reactor AF - Anaerobic Filter	GL - Ground Level PBL - Pipe Inner Bottom Level	DRAWN:	APPROVED BY:	00
P.O. Box TUNDUMA and Development Association www.borda-africa.or.tz	Dar es salaam Tanzania www.giz.de	DRAWING TITLE: CT: Layout plan and section	All concrete works to be cured to British standard BS casting of concrete. 8110	BGD - Biogas Digester PGF - Planted Gravel	RL - Reference Line WL - Water Level	SCALE (AT A3):	DATE:	_ 38	
		www.giz.de			Filter VSF - Vertical Sand Filter	GA - General arrangeme	1:45	24/03/2022	

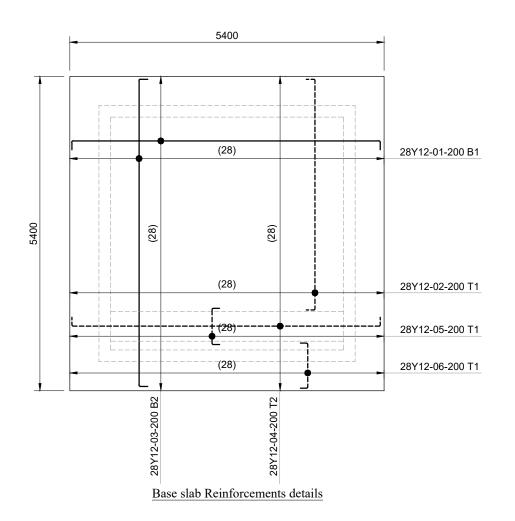

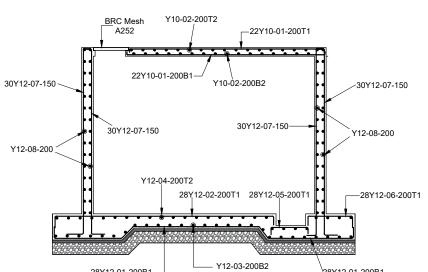

28Y12-01-200B1-28Y12-01-200B1

Section A-A Reinforcements details

GIZ P.O.BOX 1519

Dar es salaam

Tanzania www.giz.de

FUNDED BY:

BORDA

Bremen Overseas Research and Development Association

www.borda-africa.or.tz

TUNDUMA WATER SUPPLY AND SANITATION AUTHORITY

COVID 19 measures and sanitation project Mbeya and Tunduma DRAWING TITLE: CT: reinforcement details

NOTES: UIES:
This is the product of BORDA and is not to be copied or reproduced without the permission of BORDA.
All dimensions are in [mm] unless otherwise specified.
All concrete works to be cured to British standard BS

4. All earthworks shall be inspected and approved by Engineer
5. Engineer to inspect reinforcements fixing prior to casting of concrete.

ABR - Anaerobic Baffled Reactor AF - Anaerobic Filter BGD - Biogas Digester PGF - Planted Gravel

VSF - Vertical Sand Filter

BL - Bottom Level
GL - Ground Level
PBL - Pipe Inner
Bottom Level
RL - Reference Line WL - Water Level

HASE DETAILED_STRUCTURAL_DESIGN PPROVED BY I.Y I.Y

SCALE (AT A3):

1:62

39 24/03/2022

Top slab Reinforcements details

4400


(28)

(28)

(28)

22Y10-01-200 B1

22Y10-01-200 T1

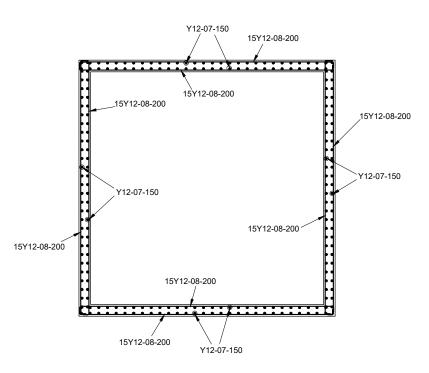

Plan: walls Reinforcements details

CT Bar Bending schedule

member	Mark	Diameter	Total Numbers/Area	Length (mm)	Unit weight (kg/m)	Total weight (kg)	Bar bending shape
Base	01	Y12	28	5650	0.888	141	
	02	Y12	28	4050	0.888	101	
	03	Y12	28	5350	0.888	133	
	04	Y12	28	5500	0.888	137	
	05	Y12	28	850	0.888	22	
	06	Y12	28	1050	0.888	27	
Walls	07	Y12	240	3550	0.888	757	
	08	Y12	120	4500	0.888	480	
Top Slab	01	Y10	88	4500	0.616	244	
					Total	2,042	

CLIENT:	CONSULTANT:	FUNDED BY:	PROJECT NAME: COVID 19 measures and sanitation project in	NOTES:	LEGEND: ABR - Anaerobic Baffled	BL - Bottom Level	PHASE DETAILED_ST	RUCTURAL_DESIGN	DRAWING NO.:
TUNDUMA WATER SUPPLY AND SANITATION AUTHORITY P.O. Box	BORDA Bremen Overseas Research and Development Association	GIZ P.O.BOX 1519 Dar es salaam	Mbeya and Tunduma	 This is the product of BORDA and is not to be copied or reproduced without the permission of BORDA. All dimensions are in [mm] unless otherwise specified. Engineer Engineer to inspect reinforcements fixing prior to 	Reactor AF - Anaerobic Filter BGD - Biogas Digester	GL - Ground Level PBL - Pipe Inner Bottom Level	DRAWN:	APPROVED BY:	40
TUNDUMA www.borda-africa.or	www.borda-africa.or.tz	Tanzania Www.giz.de DRAWING TITLE: CT: Bar bending schedule	 All concrete works to be cured to British standard BS casting of concrete. 	PGF - Planted Gravel Filter VSF - Vertical Sand Filter	RL - Reference Line WL - Water Level GA - General arrangement	SCALE (AT A3): NA	DATE: 24/03/2022		



TUNDUMA WATER SUPPLY AND SANITATION AUTHORITY P.O. Box TUNDUMA

BORDA Bremen Overseas Research and Development Association www.borda-africa.or.tz

FUNDED BY: GIZ P.O.BOX 1519 Dar es salaam

Tanzania www.giz.de

COVID 19 measures and sanitation project in Mbeya and Tunduma

DRAWING TITLE: STONE PITCHING SEPARATOR

NOTES:

1. This is the product of BORDA and is not to be copied or reproduced without the permission of BORDA.

2. All dimensions are in [mm] unless otherwise specified.

3. All concrete works to be cured to British standard BS

4. All earthworks shall be inspected and approved by Engineer

5. Engineer to inspect reinforcements fixing prior to casting of concrete. 8110

ABR - Anaerobic Baffled Reactor AF - Anaerobic Filter BGD - Biogas Digester PGF - Planted Gravel Filter


VSF - Vertical Sand Filter


BL - Bottom Level
GL - Ground Level
PBL - Pipe Inner
Bottom Level
RL - Reference Line
WL - Water Level

I.Y

1:8

PHASE DETAILED_STRUCTURAL_DESIGN 41 SCALE (AT A3): 24/03/2022

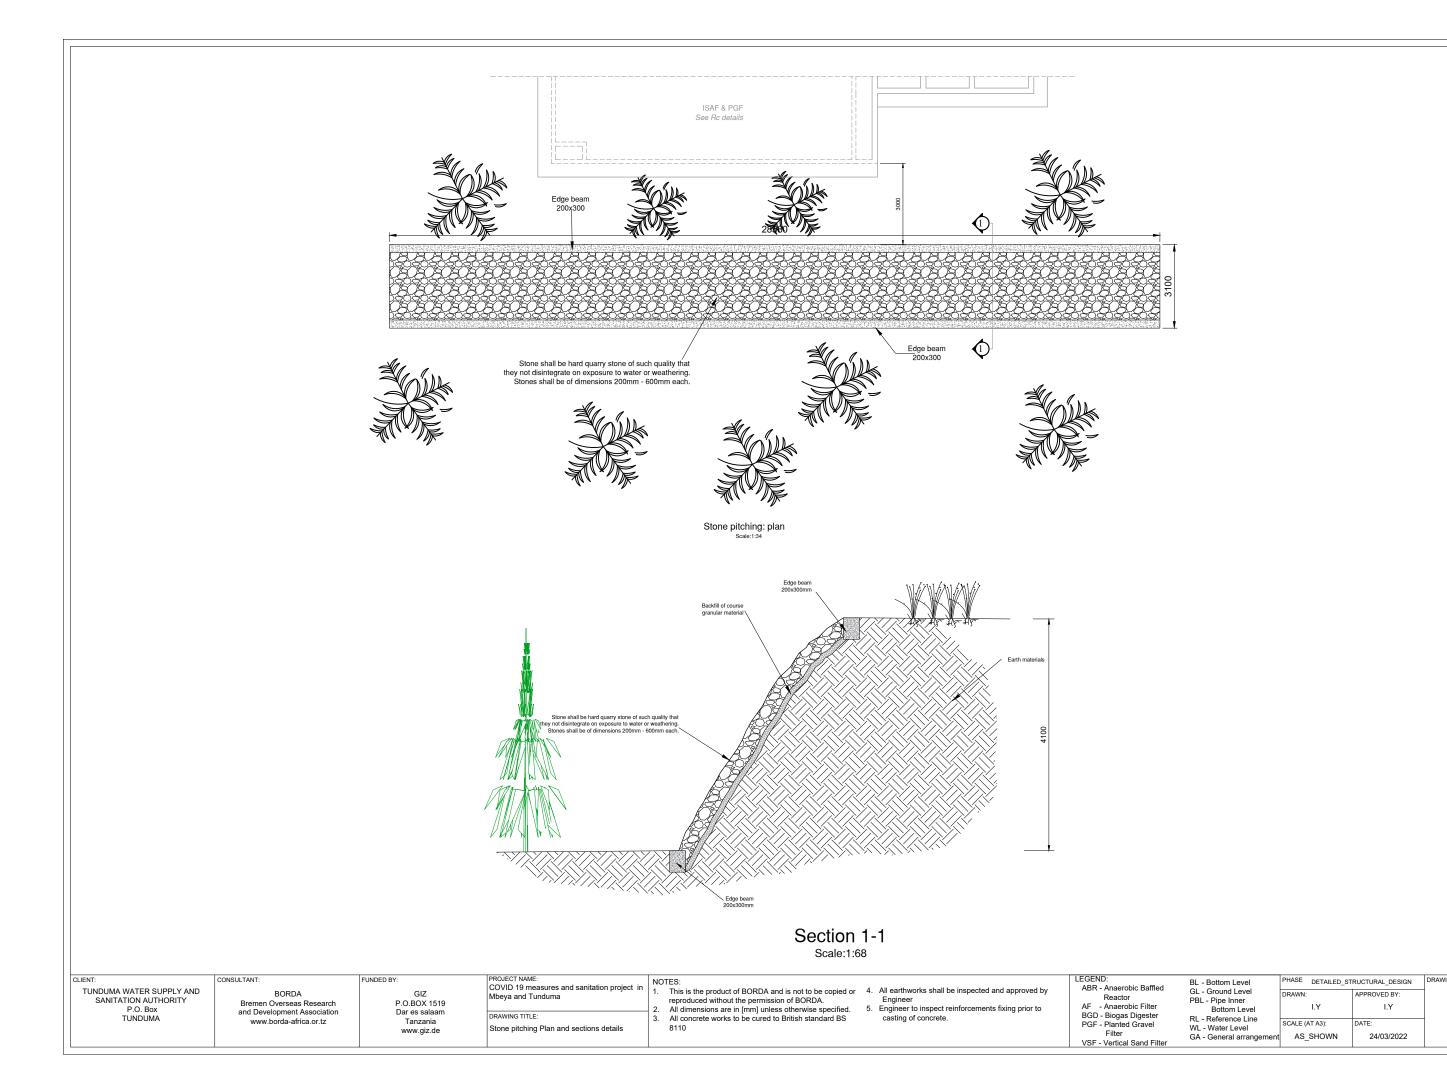

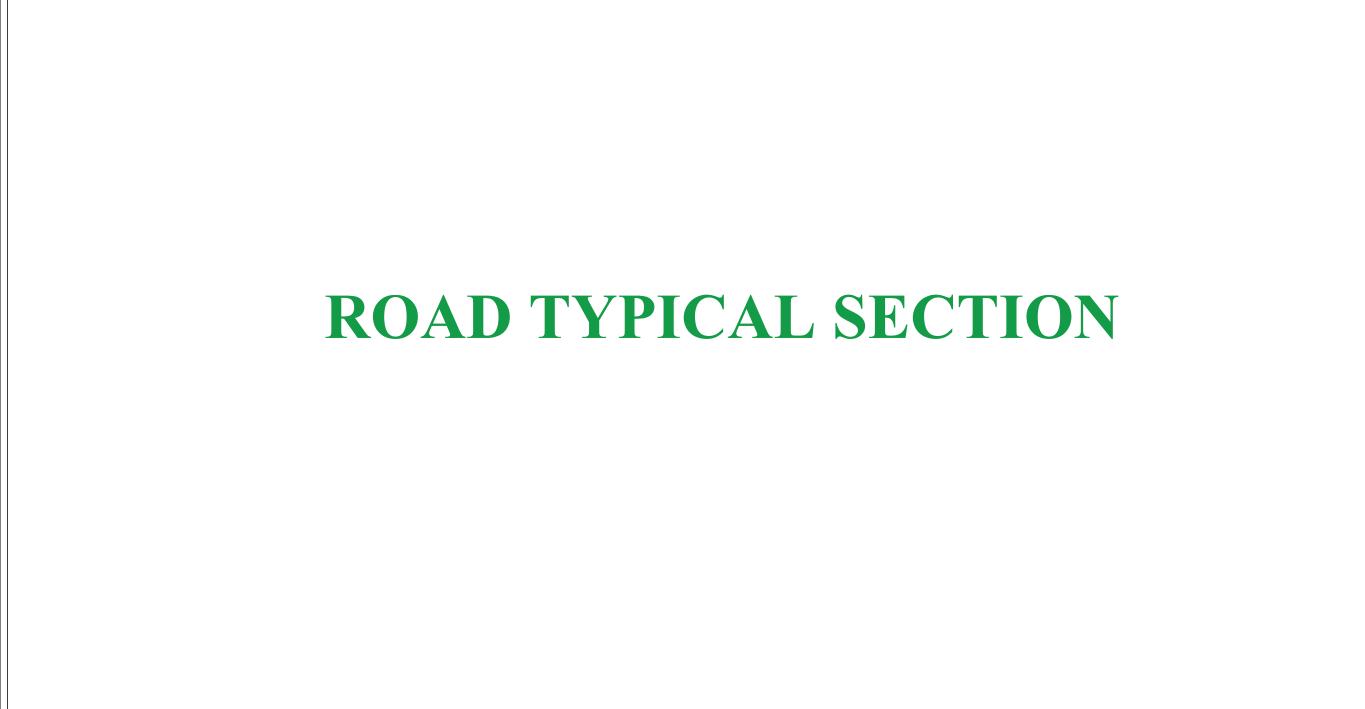

NOTES:

1. This is the product of BORDA and is not to be copied or reproduced without the permission of BORDA.

2. All dimensions are in [mm] unless otherwise specified.

3. All concrete works to be cured to British standard BS

4. All earthworks shall be inspected and approved by Engineer

5. Engineer to inspect reinforcements fixing prior to casting of concrete.

FUNDED BY:

GIZ P.O.BOX 1519

Dar es salaam Tanzania www.giz.de

BORDA

Bremen Overseas Research and Development Association

COVID 19 measures and sanitation project i Mbeya and Tunduma

ROAD SEPARATOR

TUNDUMA WATER SUPPLY AND SANITATION AUTHORITY P.O. Box TUNDUMA BL - Bottom Level
GL - Ground Level
PBL - Pipe Inner
Bottom Level
RL - Reference Line
WL - Water Level

ABR - Anaerobic Baffled Reactor

AF - Anaerobic Filter BGD - Biogas Digester PGF - Planted Gravel

VSF - Vertical Sand Filter

PHASE DETAILED_STRUCTURAL_DESIGN

24/03/2022

43

I.Y

1:8

SCALE (AT A3):

